

ZONING COMMITTEE STAFF REPORT

1. **FILE NAME:** West Side Flats Phase 3A and 3B **FILE #** 15-031-255
 2. **APPLICANT:** Sherman Associates **HEARING DATE:** October 22, 2015
 3. **TYPE OF APPLICATION:** Conditional Use Permit
 4. **LOCATION:** 59 Livingston Ave, NW corner of Livingston Ave and Fillmore Ave E
 5. **PIN & LEGAL DESCRIPTION:** 06.28.22.14.0021, Riverview Office Addition Outlot B
 6. **PLANNING DISTRICT:** 3 **PRESENT ZONING:** T3(M), RC4
 7. **ZONING CODE REFERENCE:** §66.331, §61.501
 8. **STAFF REPORT DATE:** October 13, 2015 **BY:** Lucy Thompson
 9. **DATE RECEIVED:** April 23, 2015 **NEW 60-DAY DEADLINE FOR ACTION:** November 23, 2015
(process suspended on May 11, 2015 at request of applicant; restarted at request of applicant on September 24, 2015).
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- A. **PURPOSE:** Conditional use permit for additional 6 ft. 3 in. building height over 65' permitted
- B. **PARCEL SIZE:** 237,759 square feet (5.45 acres)
- C. **EXISTING LAND USE:** vacant
- D. **SURROUNDING LAND USE:**
 - North: Mississippi River
 - East: US Bank office building
 - South: Fillmore Avenue, vacant land
 - West: railroad tracks, vacant land, West Side Flats Apartments Phase 1
- E. **ZONING CODE CITATION:** The version of §66.331(l) in effect at the time this CUP application was originally filed stated that a maximum height of 65' is permitted without a conditional use permit in the West Side Flats T3(M) district, and a maximum height of 100' may be permitted with a conditional use permit ; §61.501 lists general conditions that must be met by all conditional uses.
- F. **HISTORY/DISCUSSION:** The subject parcel is currently owned by the Saint Paul Housing and Redevelopment Authority (HRA). The HRA signed a development agreement with George Sherman (Sherman Associates) in November 2012 that allowed Mr. Sherman to do due diligence on the site, prepare a site plan and development program, and engage the West Side Community Organization (WSCO) in discussions about the project; this agreement expires on November 19, 2015. It is expected that the HRA will amend and extend the development agreement with Mr. Sherman. Mr. Sherman has been working with City staff, WSCO and the Saint Paul Design Center for most of those three years on putting together a project that meets the City, HRA and neighborhood goals for the site; is consistent with the *West Side Flats Master Plan and Development Guidelines* (2001); and is financially feasible.

Since filing for a conditional use permit for West Side Flats Phase 3A and 3B in April 2015, Mr. Sherman has continued to meet with City staff, WSCO and the Saint Paul Design Center to arrive at a site plan and project design that address concerns expressed by these groups. Out of these discussions came two alternative site plans (Options 2 and 3, discussed in more detail in Finding #6 below). The original application is Option 1.
- G. **DISTRICT COUNCIL RECOMMENDATION:** The West Side Community Organization (District 3 Council) recommends approval of a conditional use permit for Option 2 (as described in Finding #6).
- H. **FINDINGS:**
 1. West Side Flats Phase 3A and 3B is the second phase of development being proposed by Sherman Associates on the Flats. The first phase, West Side Flats Apartments, was completed in

2014, with 178 housing units and 6,000 sq. ft. of commercial space at the northeast corner of Wabasha and Fillmore. Phase 2 will be a commercial building at the Wabasha Bridgehead just north of West Side Flats Apartments; this project will follow Phase 3A and 3B.

2. West Side Flats Phase 3A and 3B (**Option 1: Initial Proposal**) consists of two buildings totaling 265 housing units and 5,000 sq. ft. of commercial space. Building 3A faces the esplanade along the top of the floodwall levee, and consists of 183 market-rate rental units and 5,000 sq. ft. of first-floor commercial space that opens onto the esplanade. Building 3B sits at the corner of Fillmore and Livingston avenues, and consists of 82 affordable rental units. Off-street parking is provided both underground and in surface lots located in the building courtyard.
3. Under **Option 1**, Building 3A is 6 stories (5 at the rooftop deck on the north side) in height, totaling 71'3". Building 3B is 5 stories in height, totaling 60'5".
4. The parcel is zoned T3(M) and is covered by the *West Side Flats Master Plan and Development Guidelines*. At the time the CUP application was filed (April 2015), the updated *West Side Flats Master Plan and Development Guidelines*, which included new maximum building height limits, had not been adopted (it was adopted in June 2015). The 2001 *West Side Flats Master Plan and Development Guidelines* was still in effect, which permitted a maximum building height of 65' without a CUP and 100' with a CUP. Under **Option 1**, Building 3A is proposed to be 71'3" high, and thus requires a CUP for the additional 6'3" of building height.
5. The original application date (for **Option 1**) was April 23, 2015. On May 11, 2015, the applicant submitted a request for continuance, asking that the public hearing be postponed and that the 60-day period requirement for a City decision be waived. On September 24, 2015, the applicant submitted a letter asking that the CUP process resume.
6. From the time the CUP application was first submitted in April 2015 through August 2015, the applicant met several times with the Riverfront, Development and Land Use Committee of WSCO; twice with the Saint Paul Design Center and several times with City staff to arrive at a site plan and project design that address concerns expressed by these groups. These concerns included building height, impact on views to and from the river, the size of Building 3A's footprint, the amount of surface parking vs. green space in the courtyard, the total number of parking spaces being provided for both residential and commercial uses, the design of the public connection between the first-floor restaurant in Building 3A and the esplanade, and other site amenities. Over those four months, two alternative site plans, Options 2 and 3, were recommended by the applicant. The number of units and amount of commercial space remains the same for all three options.

Option 2: Post-Meetings Result keeps Building 3A at 6 stories (5 stories at the rooftop deck) and Building 3B at 5 stories, but would "pop up" the corners of Building 3B to 6 stories so that the Fillmore building (3B) is taller than the river's edge building (3A). It provides less surface parking and more green space in the courtyard between the two buildings, but keeps the building footprints the same size as in the original proposal.

Option 3: Revised Proposal lowers the height of Building 3A to 5 stories (4 at the rooftop deck), while Building 3B stays at 5 stories with the 6-story pop-ups at the corners of the building. In Option 3, in order to provide the same number of housing units and enough parking for a successful restaurant, the footprint for Building 3A gets larger, and the amount of green space on the westerly edge of the site gets smaller.

7. §61.501 lists five standards that all conditional uses must satisfy:
 - (a) *The extent, location and intensity of the use will be in substantial compliance with the Saint Paul Comprehensive Plan and any applicable subarea plans which were approved by the city council.* This condition is met for all three options, but staff believes that **Option 3** better meets this standard. While the *West Side Flats Master Plan and Development Guidelines*, *Saint Paul Comprehensive Plan* and *Great River Passage Master Plan* all support a mix of

market-rate and affordable housing at urban densities on the West Side Flats with an active first-floor use that connects to the Mississippi River, staff believes that Option 3, with a shorter building at the river's edge and a taller building along Fillmore Avenue, is more consistent with the *West Side Flats Master Plan and Development Guidelines* than Options 1 or 2. It has been a fundamental design principle since 2001 that buildings be lower at the river's edge and rise in height as they move away from the river (to the south). In fact, the 2001 *West Side Flats Master Plan and Development Guidelines* states that buildings on this parcel should be 4 stories in height at the river's edge, 5 stories mid-block and 6 stories along Fillmore, which is exactly what is being proposed in Option 3.

- (b) *The use will provide adequate ingress and egress to minimize traffic congestion in the public streets.* This condition is met for all three options. Vehicles will access the site off of Livingston Avenue, and then connect to the rest of the West Side Flats street network.
- (c) *The use will not be detrimental to the existing character of the development in the immediate neighborhood or endanger the public health, safety and general welfare.* This condition is met for all three options. The proposed use will complement and enhance adjacent uses, diversify the residential market on the Flats and Greater West Side, provide new housing within walking distance of jobs, and strengthen the market for future commercial development. The proposed use will also enhance existing development by providing a public connection to the riverfront esplanade.
- (d) *The use will not impede the normal and orderly development and improvement of the surrounding property for uses permitted in the district.* This condition is met for all three options. If anything, the use will accelerate and enhance the normal and orderly development and improvement of surrounding parcels per the T3(M) permitted uses.
- (e) *The use shall, in all other respects, conform to the applicable regulations of the district in which it is located.* This condition is met for all three options.

- I. **STAFF RECOMMENDATION:** Based on the above findings, staff recommends denial of the conditional use permit for an additional 6 ft. 3 in. building height over 65' permitted for Options 1 and/or 2, and recommends approval of **Option 3: Revised Proposal**, which does not require a conditional use permit but does require site plan review. The applicant's site plan review application should reflect the building heights and building configurations depicted in the Option 3 site plan.



CONDITIONAL USE PERMIT APPLICATION
 Department of Planning and Economic Development
 Zoning Section
 1400 City Hall Annex
 25 West Fourth Street
 Saint Paul, MN 55102-1634
 (651) 266-6589

Zoning Office Use Only
 File #: 15-03/255
 Fee: _____
 Tentative Hearing Date: 5-14-15

PD=3

062822410050 JAL

APPLICANT

Name Tony J. Kuechle Email tkuechle@sherman-associates.com
 Address 233 Park Ave. South, Suite 201
 City Minneapolis State MN Zip 55415 Daytime Phone 612.604.0852
 Name of Owner (if different) St. Paul HRA
 Contact Person (if different) Jonathan Sage-Martinson Phone 651.266.6628

PROPERTY LOCATION

Address/Location Intersection of Fillmore Ave. E. and Livingston Ave.
 Legal Description Block: 3, Plat: Bazil and Robert's Addition to West St. Paul, County of Dakota, Territory of Minn.
 Lot: Outlot Plat: Riverview Office Addition Current Zoning T3M
 (attach additional sheet if necessary)

TYPE OF PERMIT:

Application is hereby made for a Conditional Use Permit under provisions of
 Chapter 61, Section 61.501, Paragraph 1, of the Zoning Code.

66.331 (L)

SUPPORTING INFORMATION: Explain how the use will meet all of the applicable standards and conditions. If you are requesting modification of any special conditions or standards for a conditional use, explain why the modification is needed and how it meets the requirements for modification of special conditions in Section 61.502 of the Zoning Code. Attach additional sheets if necessary.

The building height increased for the following reasons:

1. Due to below grade parking requirement for market rate housing.
2. To activate the first floor retail so as to communicate with the community as a whole.
3. The restaurant use will require taller ceilings for mechanical clearances.
4. Extraordinary efforts and care was taken during design on the fenestrations and stepping back the building to reduce the impact of the building height on the waterfront.

RECEIVED
 APR 23 2015
 BY: _____

Required Site Plan is attached

Applicant's Signature [Signature] Date 4/23/2015 City Agent pdd 4/23/15



1. INITIAL PROPOSAL
 IIIA 6 Stories (5 at rooftop deck)
 IIIB 5 Stories


Parking				
West Side Flats IIIA	Below Grade	Covered	Surface	Total
Residential	126	21		147
Commercial		30	21	51
				Total 198

West Side Flats IIIB	Below Grade	Surface	Total
Residential	50	36	86
			Total 86

Unit Total/Parking	Units	Residential Parking	Ratio
West Side Flats IIIA	183	147	0.80
West Side Flats IIIB	82	86	1.05

Public Street Parking			35
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option 1: Initial Proposal

Riverfront Panoramic View

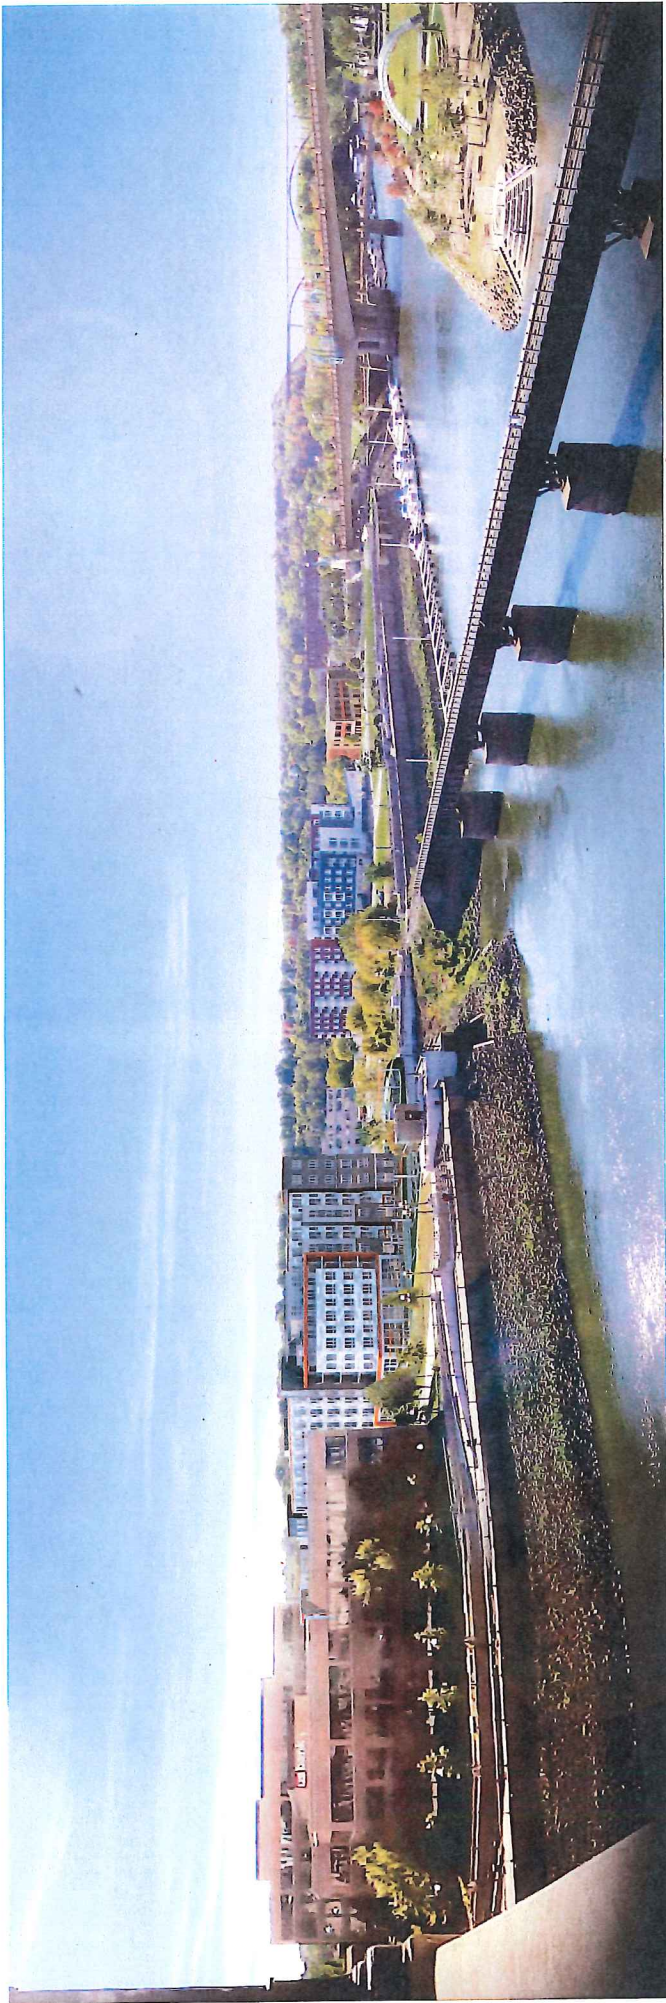

option 1: initial proposal
Phase IIIA Conceptual Rendering

KW kaas
wilson
architects
Westside Flats Phase II, IIIA & IIIB
St. Paul, MN



2. POST MEETINGS RESULT
 IIIA 6 Stories (5 at rooftop deck)
 IIIB 5 Story (6 at Lofts)

Parking				
West Side Flats IIIA	Below Grade	Covered	Surface	Total
Residential	126	21		147
Commercial		30	20	50
			Total	197

West Side Flats IIIB			
Below Grade	Surface	Total	
Residential	76	23	99
		Total	99

Unit Total/Parking			
Units	Residential Parking	Ratio	
West Side Flats IIIA	183	147	0.80
West Side Flats IIIB	82	99	1.21
Public Street Parking			17

August 2015



3. REVISED PROPOSAL
 IIIA 5 Stories (4 at rooftop deck)
 IIIB 5 Story (6 at Lofts)

Parking				
West Side Flats IIIA	Below Grade	Covered	Surface	Total
Residential		170	45	215
Commercial		30	28	58
				Total
				273

West Side Flats IIIB			
Residential	Below Grade	Surface	Total
	76	9	85
			Total
			85

Unit Total/Parking	Units	Residential Parking	Ratio
West Side Flats IIIA	182	215	1.18
West Side Flats IIIB	82	85	1.04

Public Street Parking			17
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West Side Flats Phase IIIA & IIIB
 St. Paul, MN

August 2015



3. REVISED PROPOSAL
 IIIA 5 Stories (4 at rooftop deck)
 IIIB 5 Story (6 at Lofts)

Parking					West Side Flats IIIA				West Side Flats IIIB				Unit Total/Parking		
	Below Grade	Covered	Surface	Total		Below Grade	Surface	Total		Units	Residential Parking	Ratio			
Residential		170	45	215	Residential	76	9	85	West Side Flats IIIA	182	215	1.18			
Commercial		30	27	57					West Side Flats IIIB	82	85	1.04			
				Total				Total							
															17

August 2015



options 2 and 3

Phase III B Conceptual Rendering: Option B


kaas
wilson
architects

Westside Flats Phase II, IIIA & IIIB

St. Paul, MN



TOPOGRAPHIC SURVEY FOR: SHERMAN ASSOCIATES

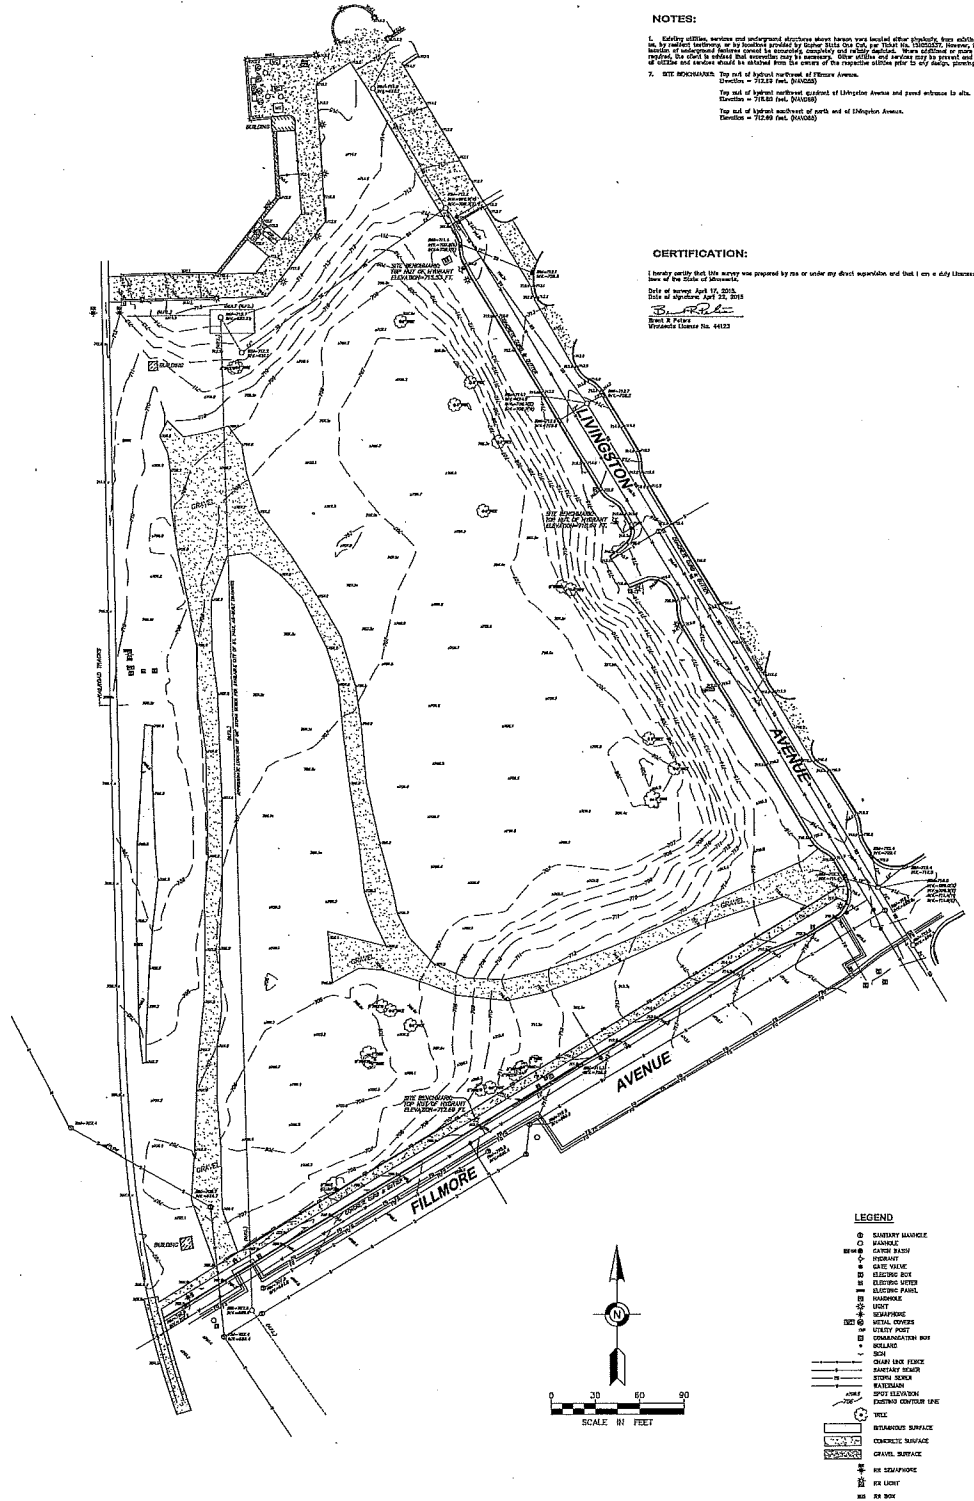

NOTES:


1. Existing utility services and underground structures shown herein were located either directly from existing records made available to us by project members, or by sounding conducted by means of the 200' and 100' SOUNDED. Accuracy, however, being dependent, for most utilities, on unobstructed surface ground to accurately determine and locate utilities. Some utilities and services may be present and not shown and location of all utilities and services should be checked from the owners of the respective utilities prior to any design, property or construction.
2. SEE MOCHAMBA. Top set of hydrological map of Fillmore Avenue.
Location = 712.28 feet (000000)
3. SEE MOCHAMBA. Top set of hydrological map of Livingston Avenue and paved entrance to site.
Location = 716.85 feet (000000)
4. SEE MOCHAMBA. Top set of hydrological map of north end of Livingston Avenue.
Location = 712.89 feet (000000)

CERTIFICATION:

I hereby certify that the survey was prepared by me or under my direct supervision and that I am a duly Licensed Land Surveyor under the laws of the State of Minnesota.
Date of Survey: July 17, 2018
Date of Report: July 17, 2018
Surveyor: [Signature]
Minnesota License No. 64123

LEGEND

- SANDWICH MANHOLE
- MANHOLE
- CURB BUSH
- FURNACE
- GAS VALVE
- ELECTRIC BOX
- ELECTRIC UTILITY
- ELECTRIC PANEL
- MANHOLE
- LIGHT
- MEASUREMENT
- METAL COVERS
- UTILITY PILE
- COMMAND CENTER BOX
- SQUARE
- SOIL
- DRIVE LINE MARK
- SANITARY MARK
- STORM MARK
- WATERMARK
- SPOT ELEVATION
- EXISTING CENTER LINE
- TIE
- BITUMINOUS SURFACE
- CONCRETE SURFACE
- GRAVEL SURFACE
- RR STRAP/POLE
- RR LIGHT
- RR BOX

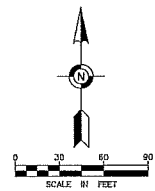

FIELD BOOK	PAGE	FULL WORK
		CHEF:
DRAWING NAME:		DRAWN BY:
JOB NO.		CHECKED BY:
FILE NO.		

**TOPOGRAPHIC
SURVEY**

SURVEY FOR:
SHERMAN ASSOCIATES

PROPERTY ADDRESS:
**WEST SIDE FLATS
ST. PAUL, MINNESOTA 55107**

EFN
Egan, Field & Nork, Inc.
1229 Tyler Street NE, Suite 100
Minneapolis, Minnesota 55413
PHONE: (612) 466-3300
FAX: (612) 466-3383
WWW.EFNSURVEY.COM
EST. 1924 • 285 5th St. S. • ST. PAUL, MN 55101

2104 G Avenue S.
Suite B
Minneapolis, MN 55404
Tel: (763) 744-4000
www.shimman.com

City: Minneapolis
State: Minnesota
55200 Broadway Boulevard
Minneapolis, MN 55412
Tel: (763) 744-4000
Fax: (763) 744-4001

Project:
14815 W. Broadway Ave.
Minneapolis, MN 55410
Project No: 2013-0001

Sheet:
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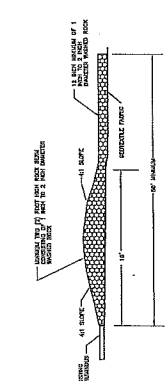
West Side Flats - Phase 3A

Shimman Associates
223 Park Avenue South, Suite 201
Minneapolis, Minnesota 55410
Date: 04/23/2015
Project Number: 1819

NOT FOR CONSTRUCTION

DETAILS


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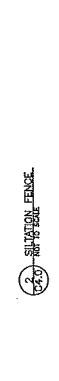
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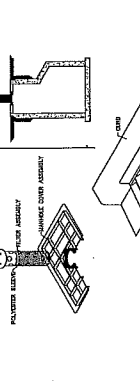
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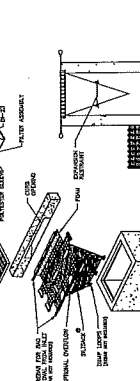
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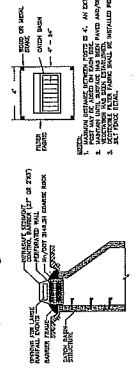
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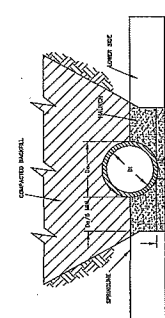
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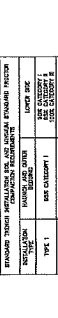
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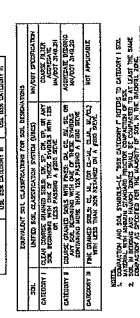
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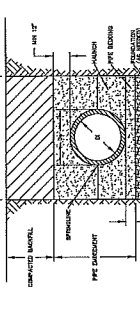
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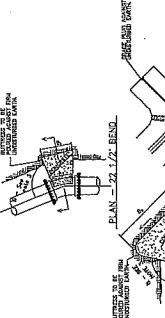
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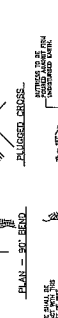
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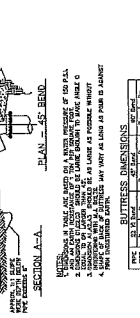
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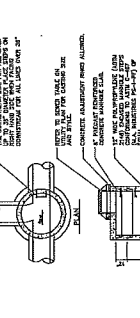
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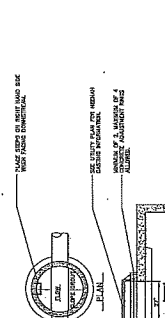
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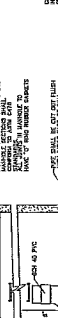
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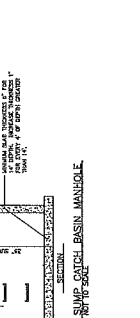
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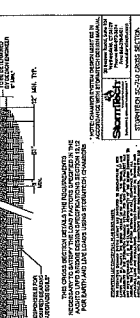
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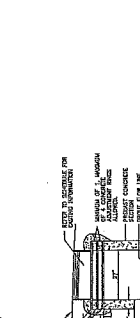
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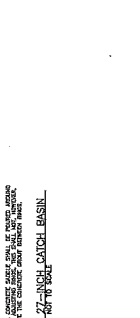
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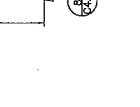
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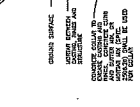
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41. SUMP CATCH BASIN MANHOLE



42. SUMP CATCH BASIN MANHOLE

NOT FOR CONSTRUCTION

DETAILS
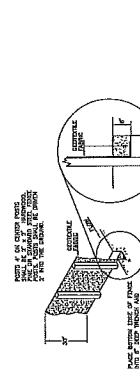
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Shimman Associates
223 Park Avenue South, Suite 201
Minneapolis, Minnesota 55410
Date: 04/23/2015
Project Number: 1819

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225 Park Avenue South, Suite 2015
 Philadelphia, Pennsylvania 19106
 Tel: (215) 778-6666
 Fax: (215) 778-6667
 www.germanassociates.com

CONTRACT NO. 101-100-0001
 SHEET NO. 101-100-0001-101

PROJECT NAME
 SHEET NO.

DATE
 DRAWN BY

CHECKED BY

APPRVED BY

PROJECT NO.

SCALE

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APPRVED BY

PROJECT NO.

SCALE

DATE

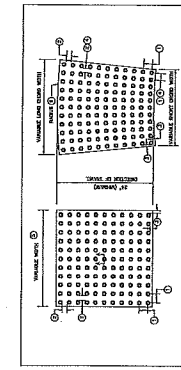


PLATE NO.	PLATE TYPE	PLATE DIMENSIONS	PLATE LOCATION
1	1' x 2'	1' x 2'	...
2	1' x 2'	1' x 2'	...
3	1' x 2'	1' x 2'	...
4	1' x 2'	1' x 2'	...
5	1' x 2'	1' x 2'	...
6	1' x 2'	1' x 2'	...
7	1' x 2'	1' x 2'	...
8	1' x 2'	1' x 2'	...
9	1' x 2'	1' x 2'	...
10	1' x 2'	1' x 2'	...
11	1' x 2'	1' x 2'	...
12	1' x 2'	1' x 2'	...
13	1' x 2'	1' x 2'	...
14	1' x 2'	1' x 2'	...
15	1' x 2'	1' x 2'	...
16	1' x 2'	1' x 2'	...
17	1' x 2'	1' x 2'	...
18	1' x 2'	1' x 2'	...
19	1' x 2'	1' x 2'	...
20	1' x 2'	1' x 2'	...
21	1' x 2'	1' x 2'	...
22	1' x 2'	1' x 2'	...
23	1' x 2'	1' x 2'	...
24	1' x 2'	1' x 2'	...
25	1' x 2'	1' x 2'	...
26	1' x 2'	1' x 2'	...
27	1' x 2'	1' x 2'	...
28	1' x 2'	1' x 2'	...
29	1' x 2'	1' x 2'	...
30	1' x 2'	1' x 2'	...

NOTE: ALL PLATES SHALL BE CAST IN PLACE CONCRETE WITH A MINIMUM THICKNESS OF 4" AND A FINISH TO MATCH THE ADJACENT SURFACE. SEE NOTES APPROVED/CHANGED BY: DATE: PROJECT NO. SHEET NO. 101-100-0001-101

REVISION NO.	DESCRIPTION	DATE
1
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DETECTABLE WALKING SURFACE
 REFERENCE: 703BA

NOTE: FOR ADA COMPLIANT PEDESTRIAN RAMP, REFER TO IN/OUT STANDARD PLAN 101-100-0001-101 FOR DETAILS. CONTRACTOR SHALL COORDINATE FINAL CURB RAMP LOCATION AND PEDESTRIAN CURB RAMP DETAIL WITH THE CITY AND OWNER PRIOR TO INSTALLATION.



NOTE: CURB SHALL BE CAST IN PLACE CONCRETE WITH A MINIMUM THICKNESS OF 4" AND A FINISH TO MATCH THE ADJACENT SURFACE. SEE NOTES APPROVED/CHANGED BY: DATE: PROJECT NO. SHEET NO. 101-100-0001-101




NOTE: GUTTER SHALL BE CAST IN PLACE CONCRETE WITH A MINIMUM THICKNESS OF 4" AND A FINISH TO MATCH THE ADJACENT SURFACE. SEE NOTES APPROVED/CHANGED BY: DATE: PROJECT NO. SHEET NO. 101-100-0001-101



NOTE: SIDEWALK SHALL BE CAST IN PLACE CONCRETE WITH A MINIMUM THICKNESS OF 4" AND A FINISH TO MATCH THE ADJACENT SURFACE. SEE NOTES APPROVED/CHANGED BY: DATE: PROJECT NO. SHEET NO. 101-100-0001-101



NOTE: PAVEMENT SHALL BE CAST IN PLACE BITUMINOUS CONCRETE WITH A MINIMUM THICKNESS OF 4" AND A FINISH TO MATCH THE ADJACENT SURFACE. SEE NOTES APPROVED/CHANGED BY: DATE: PROJECT NO. SHEET NO. 101-100-0001-101

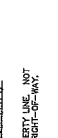

NOTE: RAIN GARDEN SHALL BE CAST IN PLACE CONCRETE WITH A MINIMUM THICKNESS OF 4" AND A FINISH TO MATCH THE ADJACENT SURFACE. SEE NOTES APPROVED/CHANGED BY: DATE: PROJECT NO. SHEET NO. 101-100-0001-101




NOTE: CURB RAMP SHALL BE CAST IN PLACE CONCRETE WITH A MINIMUM THICKNESS OF 4" AND A FINISH TO MATCH THE ADJACENT SURFACE. SEE NOTES APPROVED/CHANGED BY: DATE: PROJECT NO. SHEET NO. 101-100-0001-101




NOTE: CURB AND GUTTER SHALL BE CAST IN PLACE CONCRETE WITH A MINIMUM THICKNESS OF 4" AND A FINISH TO MATCH THE ADJACENT SURFACE. SEE NOTES APPROVED/CHANGED BY: DATE: PROJECT NO. SHEET NO. 101-100-0001-101



NOTE: SIGN AND POST SHALL BE CAST IN PLACE CONCRETE WITH A MINIMUM THICKNESS OF 4" AND A FINISH TO MATCH THE ADJACENT SURFACE. SEE NOTES APPROVED/CHANGED BY: DATE: PROJECT NO. SHEET NO. 101-100-0001-101

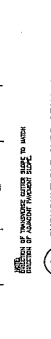

NOTE: CURB SHALL BE CAST IN PLACE CONCRETE WITH A MINIMUM THICKNESS OF 4" AND A FINISH TO MATCH THE ADJACENT SURFACE. SEE NOTES APPROVED/CHANGED BY: DATE: PROJECT NO. SHEET NO. 101-100-0001-101

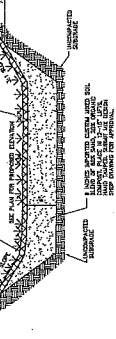

NOTE: RAIN GARDEN SHALL BE CAST IN PLACE CONCRETE WITH A MINIMUM THICKNESS OF 4" AND A FINISH TO MATCH THE ADJACENT SURFACE. SEE NOTES APPROVED/CHANGED BY: DATE: PROJECT NO. SHEET NO. 101-100-0001-101




NOTE: RAIN GARDEN SHALL BE CAST IN PLACE CONCRETE WITH A MINIMUM THICKNESS OF 4" AND A FINISH TO MATCH THE ADJACENT SURFACE. SEE NOTES APPROVED/CHANGED BY: DATE: PROJECT NO. SHEET NO. 101-100-0001-101



NOTE: RAIN GARDEN SHALL BE CAST IN PLACE CONCRETE WITH A MINIMUM THICKNESS OF 4" AND A FINISH TO MATCH THE ADJACENT SURFACE. SEE NOTES APPROVED/CHANGED BY: DATE: PROJECT NO. SHEET NO. 101-100-0001-101



NOTE: RAIN GARDEN SHALL BE CAST IN PLACE CONCRETE WITH A MINIMUM THICKNESS OF 4" AND A FINISH TO MATCH THE ADJACENT SURFACE. SEE NOTES APPROVED/CHANGED BY: DATE: PROJECT NO. SHEET NO. 101-100-0001-101

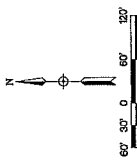

DATE: 08/23/2010
PROJECT: WEST SIDE FLATS - PHASE 3A
CLIENT: SHERRILL HOLDINGS LLC
DESIGNER: SHERMAN ASSOCIATES
CONTRACT NO.: 1574
PHASE: PRELIMINARY DESIGN
DATE: 08/23/2010

REVISION	DATE	DESCRIPTION
1	08/23/2010	ISSUED FOR PERMITTING

CONSTRUCTION SCHEDULE:
Construction activities shall be scheduled to avoid the winter months (November through February) as much as possible. Construction activities shall be limited to a maximum of 10 hours per day during the winter months. Construction activities shall be limited to a maximum of 10 hours per day during the winter months.

GENERAL NOTES:
1. THIS PLAN SHOWS THE PROPOSED STORMWATER POLLUTION PREVENTION PLAN (SWPPP) FOR THE WEST SIDE FLATS - PHASE 3A. THE SWPPP IS TO BE USED TO PREVENT POLLUTION FROM THE CONSTRUCTION AND MAINTENANCE OF THE PROJECT.

CONSTRUCTION SCHEDULE:
Construction activities shall be scheduled to avoid the winter months (November through February) as much as possible. Construction activities shall be limited to a maximum of 10 hours per day during the winter months.

GENERAL NOTES:
2. THE PROPOSED SWPPP IS TO BE USED TO PREVENT POLLUTION FROM THE CONSTRUCTION AND MAINTENANCE OF THE PROJECT. THE SWPPP IS TO BE USED TO PREVENT POLLUTION FROM THE CONSTRUCTION AND MAINTENANCE OF THE PROJECT.

GENERAL NOTES:
3. THE PROPOSED SWPPP IS TO BE USED TO PREVENT POLLUTION FROM THE CONSTRUCTION AND MAINTENANCE OF THE PROJECT. THE SWPPP IS TO BE USED TO PREVENT POLLUTION FROM THE CONSTRUCTION AND MAINTENANCE OF THE PROJECT.

GENERAL NOTES:
4. THE PROPOSED SWPPP IS TO BE USED TO PREVENT POLLUTION FROM THE CONSTRUCTION AND MAINTENANCE OF THE PROJECT. THE SWPPP IS TO BE USED TO PREVENT POLLUTION FROM THE CONSTRUCTION AND MAINTENANCE OF THE PROJECT.



GENERAL NOTES:
5. THE PROPOSED SWPPP IS TO BE USED TO PREVENT POLLUTION FROM THE CONSTRUCTION AND MAINTENANCE OF THE PROJECT. THE SWPPP IS TO BE USED TO PREVENT POLLUTION FROM THE CONSTRUCTION AND MAINTENANCE OF THE PROJECT.

GENERAL NOTES:
6. THE PROPOSED SWPPP IS TO BE USED TO PREVENT POLLUTION FROM THE CONSTRUCTION AND MAINTENANCE OF THE PROJECT. THE SWPPP IS TO BE USED TO PREVENT POLLUTION FROM THE CONSTRUCTION AND MAINTENANCE OF THE PROJECT.

GENERAL NOTES:
7. THE PROPOSED SWPPP IS TO BE USED TO PREVENT POLLUTION FROM THE CONSTRUCTION AND MAINTENANCE OF THE PROJECT. THE SWPPP IS TO BE USED TO PREVENT POLLUTION FROM THE CONSTRUCTION AND MAINTENANCE OF THE PROJECT.

REVISIONS

NO.	DATE	DESCRIPTION
1	08/23/2010	ISSUED FOR PERMITTING

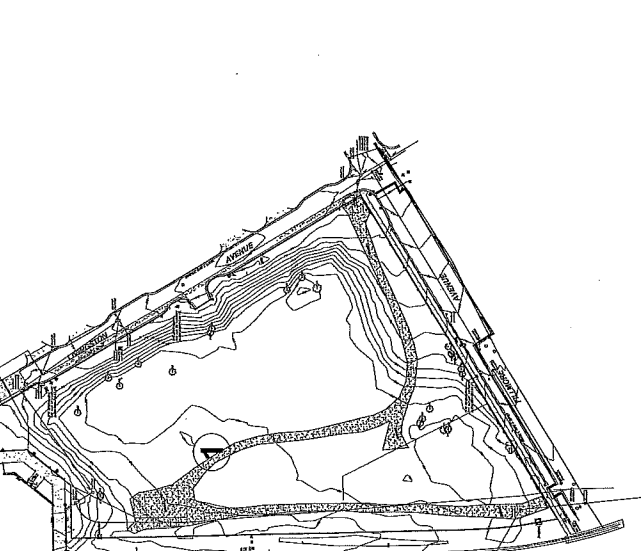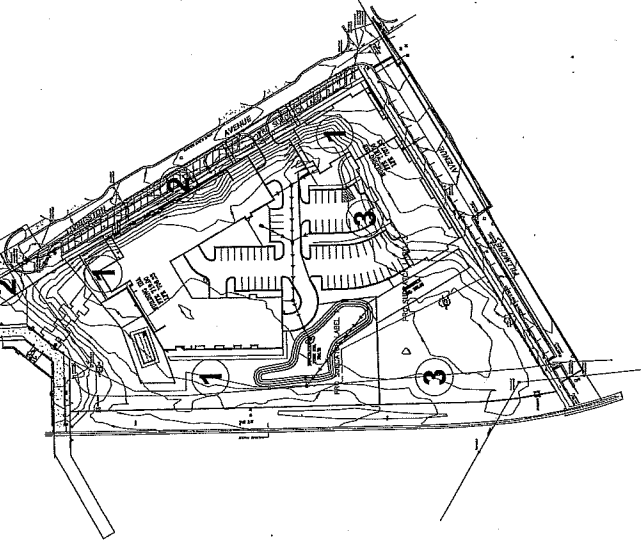

PROPOSED CONDITIONS


DRAINAGE AREA	PROPOSED AREA (AC)	EXISTING AREA (AC)	DIFFERENCE (AC)
TOTAL	1.24	1.24	0.00

EXISTING CONDITIONS

DRAINAGE AREA	PROPOSED AREA (AC)	EXISTING AREA (AC)	DIFFERENCE (AC)
TOTAL	1.24	1.24	0.00

STORMWATER RUNOFF SUMMARY

24-H RAINFALL RATE (INCHES)	15-MIN RAINFALL RATE (INCHES)	60-MIN RAINFALL RATE (INCHES)
1.24	0.50	0.25

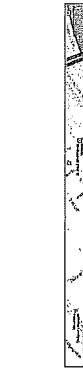

COUNTY MAP
© COPYRIGHT GOOGLE MAPS



1515 38th Avenue S.
 Suite 100
 Minneapolis, MN 55412
 Tel: (612) 771-4444
 Fax: (612) 771-4444
 www.a120.com

Lead Architect
 Croy Design Group
 222 Park Avenue South, Suite 200
 Minneapolis, MN 55402
 Tel: (612) 338-4444

MEP
 Structural

Project
 West Side Flats - Phase 3A and 3B
 1515 38th Avenue S.
 Minneapolis, MN 55412

Client
 Ghormley Associates
 222 Park Avenue South, Suite 200
 Minneapolis, MN 55402
 Tel: (612) 338-4444


Date
 1/15/15
 Project Number
 1515 38th Avenue S, A120-15
 Drawing Number
 A120-15-01

NOT FOR CONSTRUCTION

Rev. No.
 Revision
 Date

Architectural Site
 Plan - 3A & 3B
 1" = 30'-0"
A120

SPECIAL NOTES:
 1. ALL BUILDINGS SHALL BE CONSTRUCTED IN ACCORDANCE WITH THE CITY OF MINNEAPOLIS ORDINANCES AND THE MINNEAPOLIS FIRE DEPARTMENT (MFD) REQUIREMENTS.
 2. ALL BUILDINGS SHALL BE CONSTRUCTED IN ACCORDANCE WITH THE CITY OF MINNEAPOLIS ORDINANCES AND THE MINNEAPOLIS FIRE DEPARTMENT (MFD) REQUIREMENTS.
 3. ALL BUILDINGS SHALL BE CONSTRUCTED IN ACCORDANCE WITH THE CITY OF MINNEAPOLIS ORDINANCES AND THE MINNEAPOLIS FIRE DEPARTMENT (MFD) REQUIREMENTS.
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 9. ALL BUILDINGS SHALL BE CONSTRUCTED IN ACCORDANCE WITH THE CITY OF MINNEAPOLIS ORDINANCES AND THE MINNEAPOLIS FIRE DEPARTMENT (MFD) REQUIREMENTS.
 10. ALL BUILDINGS SHALL BE CONSTRUCTED IN ACCORDANCE WITH THE CITY OF MINNEAPOLIS ORDINANCES AND THE MINNEAPOLIS FIRE DEPARTMENT (MFD) REQUIREMENTS.

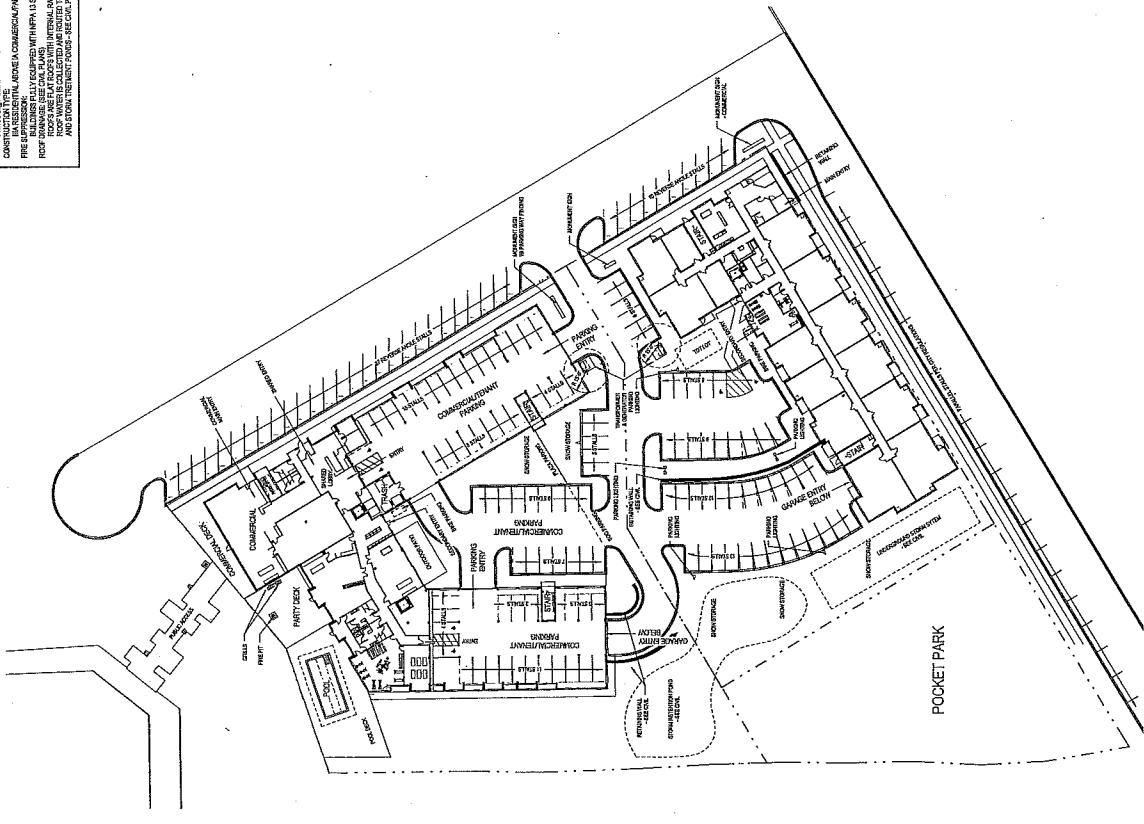

North Arrow
 1" = 30'-0"

NOT FOR CONSTRUCTION

Date: 03/20/2018
Project Number: 1518

Shorman Associates
223 Park Avenue South, Suite 201
Birmingham, Massachusetts 06116

West Side Flats - Phase 3A and 3B
Westmore Ave & Fenwick Ave


Client: [Redacted]
Architect: [Redacted]
Contract: [Redacted]
Location: [Redacted]
Scale: [Redacted]
Date: [Redacted]

EXTERIOR ELEVATION - SOUTH 3
1/8" = 1'-0"


1. ALL DIMENSIONS OF EXTERIOR WALLS AND INTERIOR WALLS SHALL BE TO FACE UNLESS OTHERWISE NOTED.
2. EXTERIOR WALLS SHALL BE CONSTRUCTED WITH 8" CMU WITH 2" EXTERIOR FINISH AND 2" INTERIOR FINISH.
3. INTERIOR WALLS SHALL BE CONSTRUCTED WITH 5/8" GYP BOARD ON 2" X 4" STUDS.
4. INTERIOR FLOORS SHALL BE CONSTRUCTED WITH 4" CONCRETE ON 2" X 8" JOISTS.
5. INTERIOR CEILING SHALL BE CONSTRUCTED WITH 5/8" GYP BOARD ON 2" X 4" STUDS.
6. INTERIOR ROOF SHALL BE CONSTRUCTED WITH 4" CONCRETE ON 2" X 8" JOISTS.
7. INTERIOR STAIRS SHALL BE CONSTRUCTED WITH 4" CONCRETE ON 2" X 8" JOISTS.
8. INTERIOR ELEVATORS SHALL BE CONSTRUCTED WITH 4" CONCRETE ON 2" X 8" JOISTS.
9. INTERIOR MECHANICAL ROOMS SHALL BE CONSTRUCTED WITH 4" CONCRETE ON 2" X 8" JOISTS.
10. INTERIOR ELECTRICAL ROOMS SHALL BE CONSTRUCTED WITH 4" CONCRETE ON 2" X 8" JOISTS.

FINISH SCHEDULE

CONCRETE FLOOR FINISH	CONCRETE FLOOR FINISH
CONCRETE WALL FINISH	CONCRETE WALL FINISH
CONCRETE CEILING FINISH	CONCRETE CEILING FINISH
CONCRETE ROOF FINISH	CONCRETE ROOF FINISH
CONCRETE STAIR FINISH	CONCRETE STAIR FINISH
CONCRETE ELEVATOR FINISH	CONCRETE ELEVATOR FINISH
CONCRETE MECHANICAL FINISH	CONCRETE MECHANICAL FINISH
CONCRETE ELECTRICAL FINISH	CONCRETE ELECTRICAL FINISH

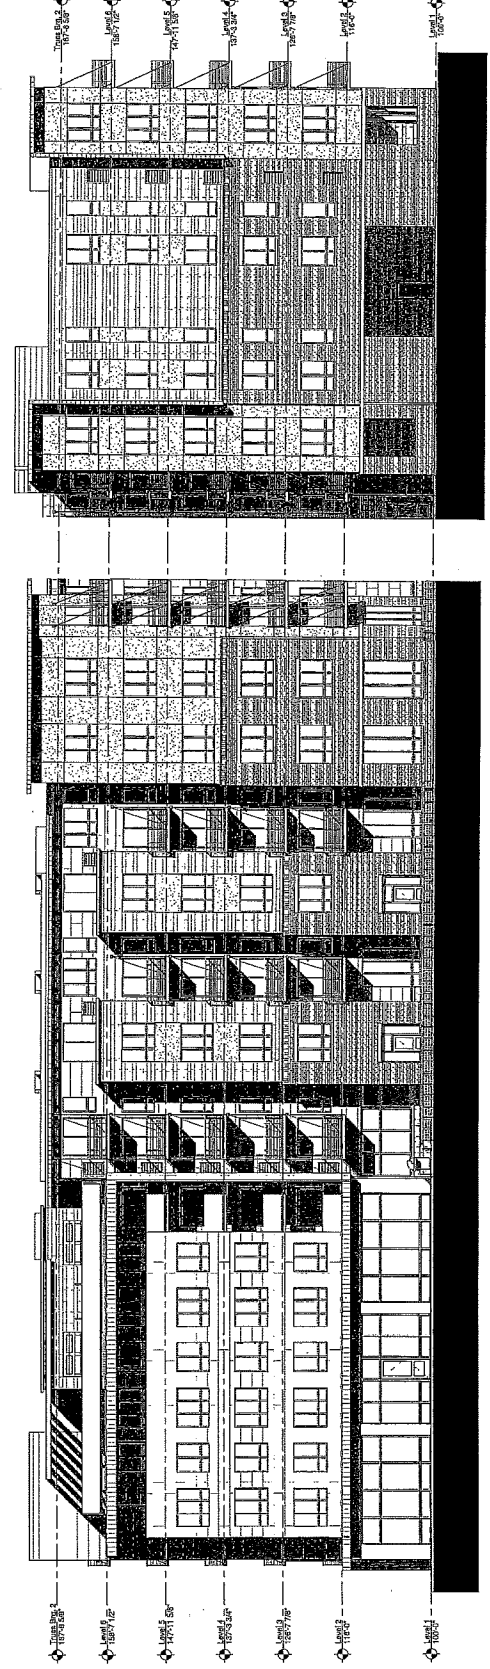

Exterior Elevation - South 3
1/8" = 1'-0"

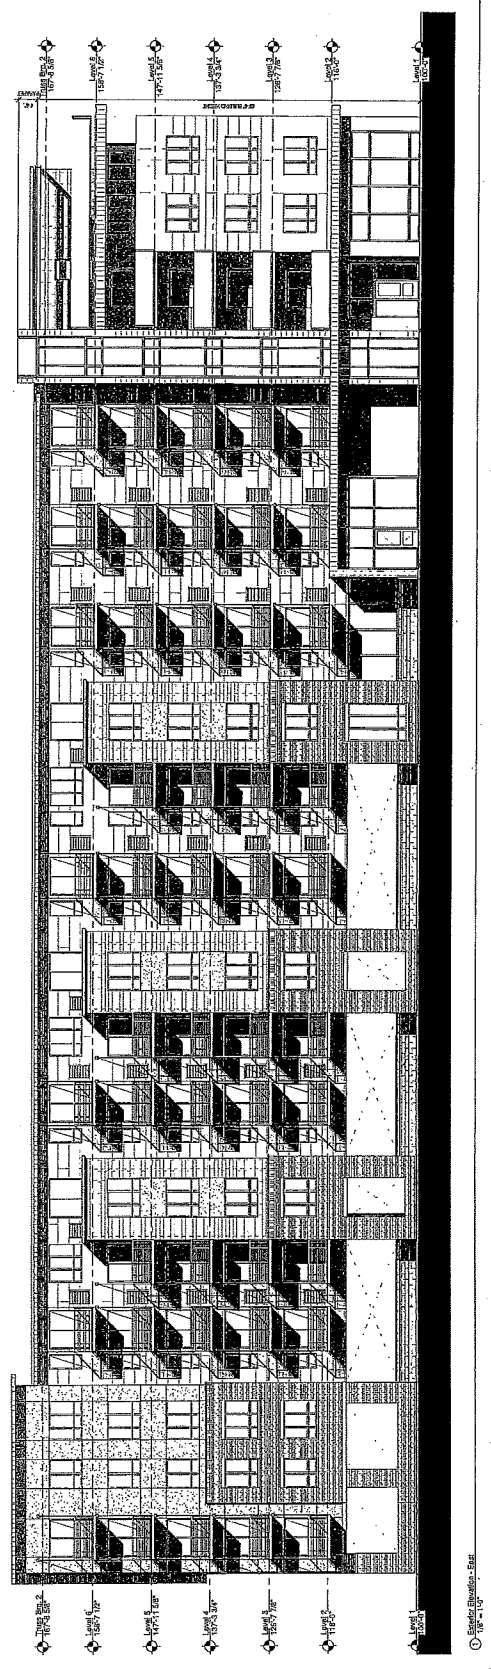


Exterior Elevation - East
1/8" = 1'-0"

2104 4th Avenue S.
 Suite 8
 Minneapolis, MN 55404
 Tel: (612) 371-4000
 Fax: (612) 371-4000
 www.aaa.com
 CHARMAN ASSOCIATES
 2300 Hennepin Avenue
 Minneapolis, MN 55405
 Tel: (612) 371-4000
 Fax: (612) 371-4000
 www.charman.com
 CHARMAN ASSOCIATES
 2300 Hennepin Avenue
 Minneapolis, MN 55405
 Tel: (612) 371-4000
 Fax: (612) 371-4000
 www.charman.com


Project: West Side Flats - Phase 3A and 3B
 Location: Ulysses Ave & Ely Ave, Minneapolis, MN
 Architect: CHARMAN ASSOCIATES
 Date: 10/15/15
 Scale: 1/8" = 1'-0"

Project: West Side Flats - Phase 3A and 3B
 Location: Ulysses Ave & Ely Ave, Minneapolis, MN
 Architect: CHARMAN ASSOCIATES
 Date: 10/15/15
 Scale: 1/8" = 1'-0"

NOT FOR CONSTRUCTION
 CHARMAN ASSOCIATES
 2300 Hennepin Avenue, Suite 201
 Minneapolis, Minnesota 55405
 Phone: (612) 371-4000
 Fax: (612) 371-4000
 www.charman.com

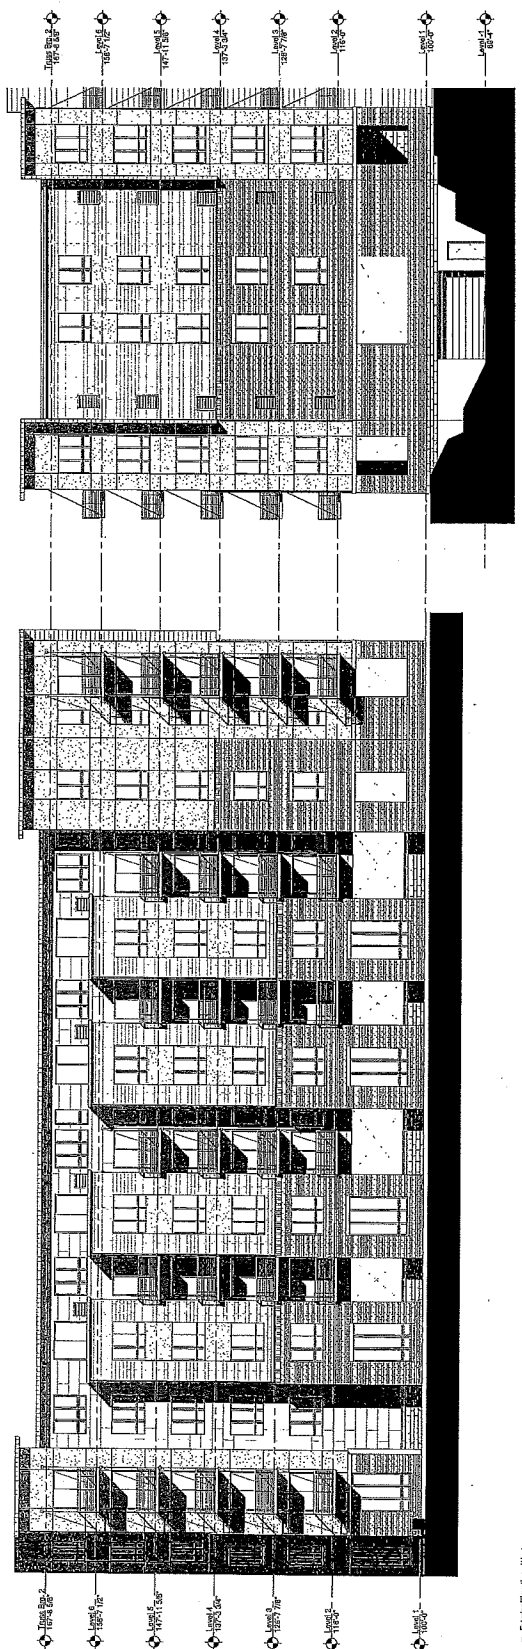

Exterior Elevation - West
 1/8" = 1'-0"

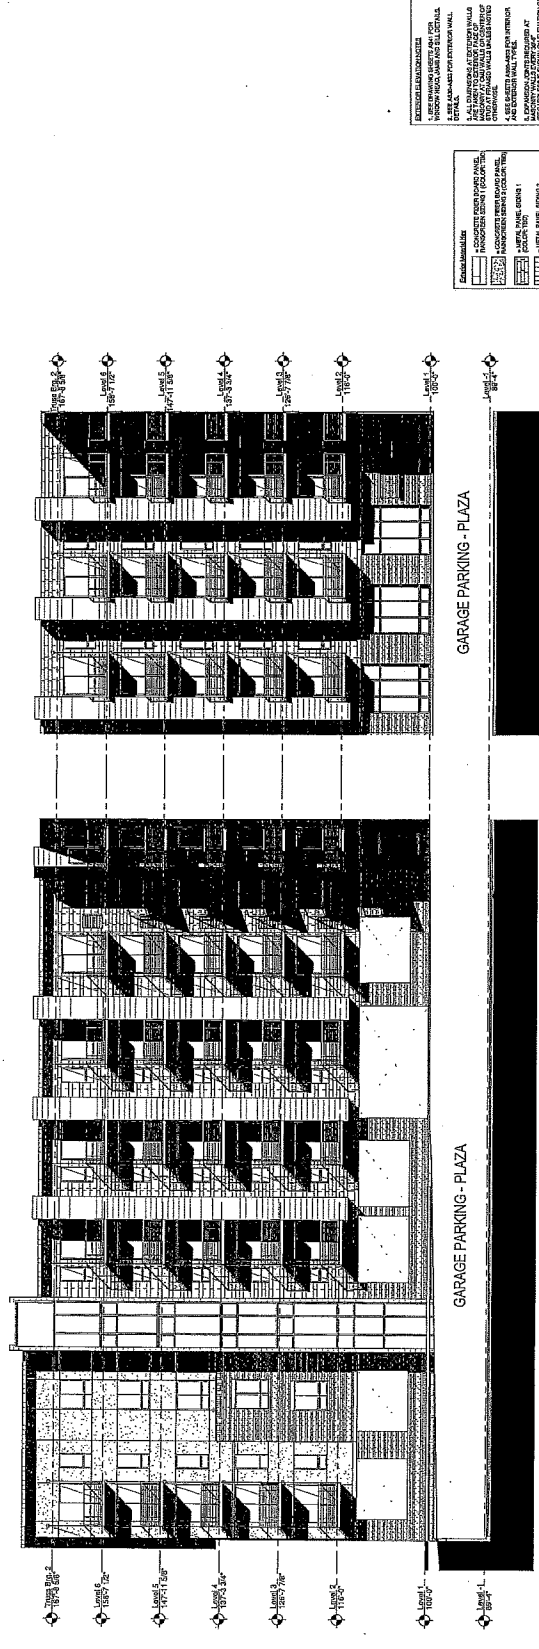

Exterior Elevation - South
 1/8" = 1'-0"

EXTERIOR ELEVATION NOTES:
 1. ALL MATERIALS SHALL BE AS SHOWN UNLESS NOTED OTHERWISE.
 2. ALL MATERIALS SHALL BE AS SHOWN UNLESS NOTED OTHERWISE.
 3. ALL MATERIALS SHALL BE AS SHOWN UNLESS NOTED OTHERWISE.
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FINISHES:
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 2. CONCRETE FLOOR FINISH
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 8. CONCRETE FLOOR FINISH
 9. CONCRETE FLOOR FINISH
 10. CONCRETE FLOOR FINISH

EXTERIOR ELEVATION - 3A
 As indicated
 A501

GARAGE PARKING - PLAZA

GARAGE PARKING - PLAZA

Project: West Side Flats - Phase 3A and 3B
 Location: 18th Ave S & Irving Ave.
 Client: Sherman Associates
 223 Park Avenue South, Suite 201
 Minneapolis, Minnesota 55401

Date: 8/18/2015
 Project Number: 1518
 Drawing: 818-03-015

Exterior Elevations - 3A
 As Indicated
A502

NOT FOR CONSTRUCTION

EXTERIOR ELEVATION MATERIALS:
 1. ALL MATERIALS TO BE APPROVED BY ARCHITECT AND CONTRACTOR.
 2. ALL MATERIALS TO BE APPROVED BY ARCHITECT AND CONTRACTOR.
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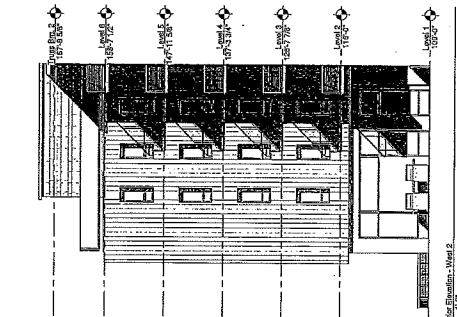
FINISHES:
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NOTES:
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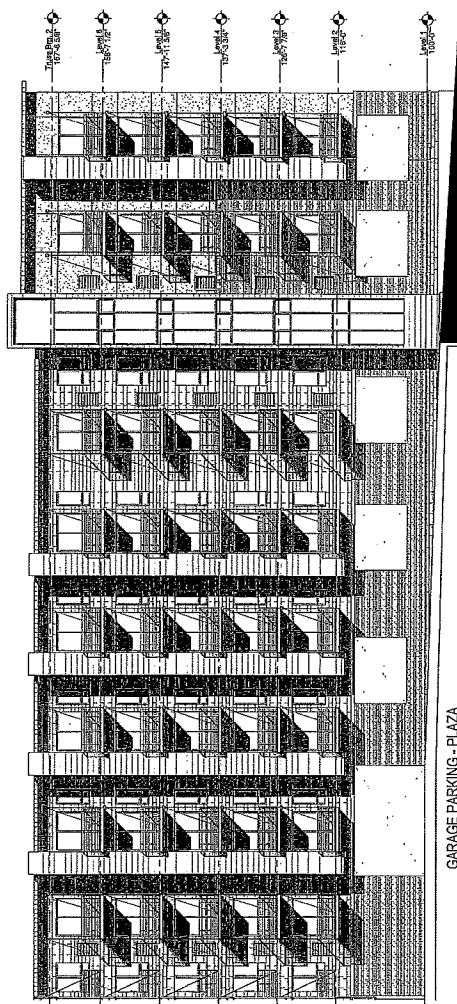
GENERAL NOTES:
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GENERAL NOTES:
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GENERAL NOTES:
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 8. ALL MATERIALS TO BE APPROVED BY ARCHITECT AND CONTRACTOR.
 9. ALL MATERIALS TO BE APPROVED BY ARCHITECT AND CONTRACTOR.
 10. ALL MATERIALS TO BE APPROVED BY ARCHITECT AND CONTRACTOR.



100'-0"
 100'-10"
 100'-20"
 100'-30"
 100'-40"
 100'-50"
 100'-60"
 100'-70"
 100'-80"
 100'-90"
 100'-10"




100'-0"
 100'-10"
 100'-20"
 100'-30"
 100'-40"
 100'-50"
 100'-60"
 100'-70"
 100'-80"
 100'-90"
 100'-10"

GARAGE PARKING - PLAZA
 100'-0"
 100'-10"
 100'-20"
 100'-30"
 100'-40"
 100'-50"
 100'-60"
 100'-70"
 100'-80"
 100'-90"
 100'-10"


1307 Avenue B, Unit 100
 New York, NY 10025
 Tel: 212 696 1525
 Fax: 212 696 1526
 www.shermanassociates.com

Client:
 3703 Eastchester Road
 Eastchester, NY 10924
 Tel: 718 224 2200

Architect:
 Clark Sifton Group
 100 West 42nd Street
 12th Floor, New York, NY 10018
 Tel: 212 693 6976

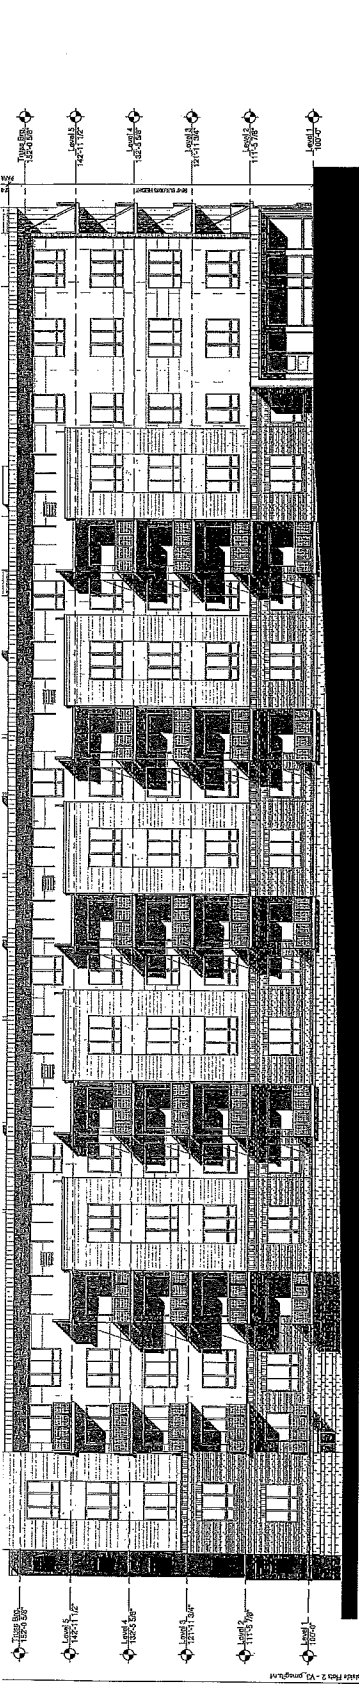

Project:
 West Side Flats - Phase 3B
 21st St, NY

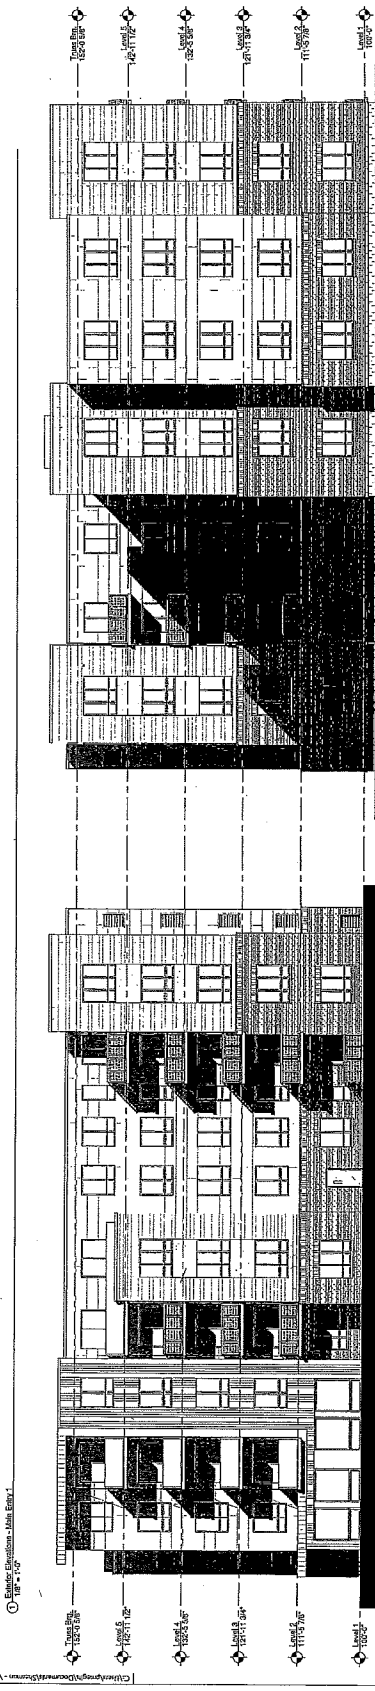


Sherman Associates
 Project Number:
 Date:




NOT FOR CONSTRUCTION

Key: No. Elevation
 Exterior Elevations - 3B
 As Indicated
A503

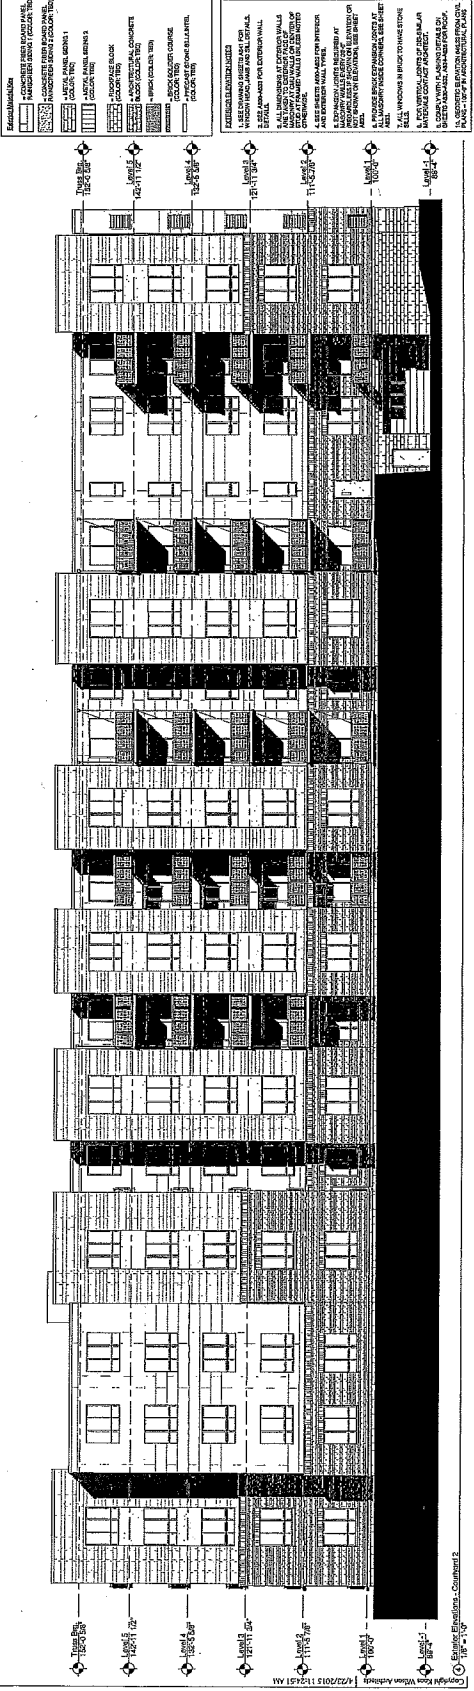


EXPLANATION
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 4. CONCRETE FROM FOUNDATION TO TOP OF WALL
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 99. CONCRETE FROM FOUNDATION TO TOP OF WALL
 100. CONCRETE FROM FOUNDATION TO TOP OF WALL

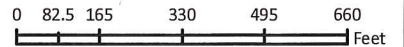

FILE NAME: West Side Flats Phase 3A and 3B

Aerial

APPLICATION TYPE: CUP


 Subject Parcels

FILE #: 15-031255 DATE: 4/30/2015

PLANNING DISTRICT: 3

ZONING PANEL: 16



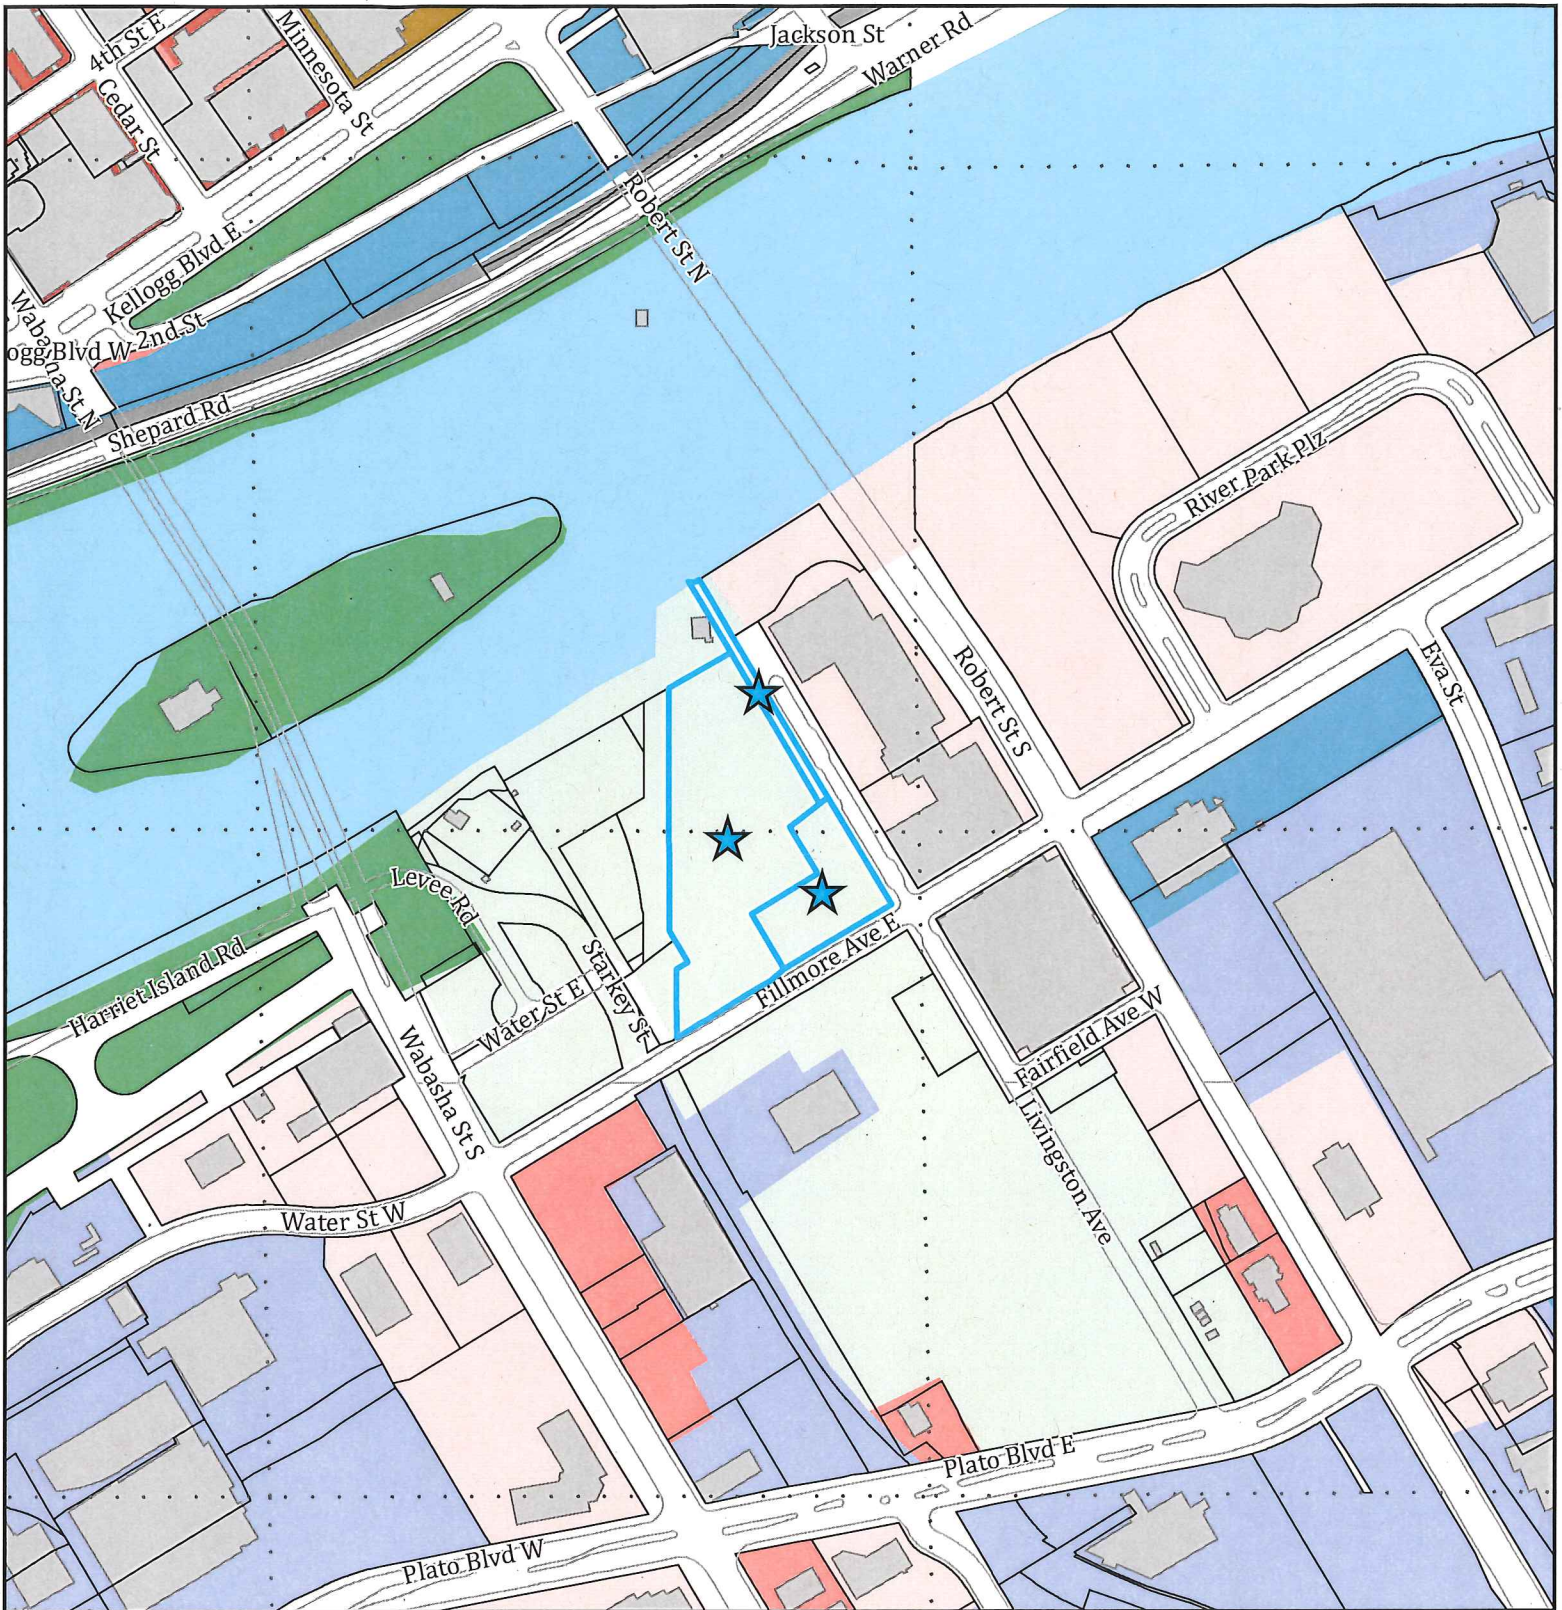

FILE NAME: West Side Flats Phase 3A and 3B

APPLICATION TYPE: CUP


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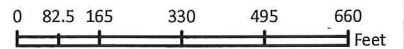
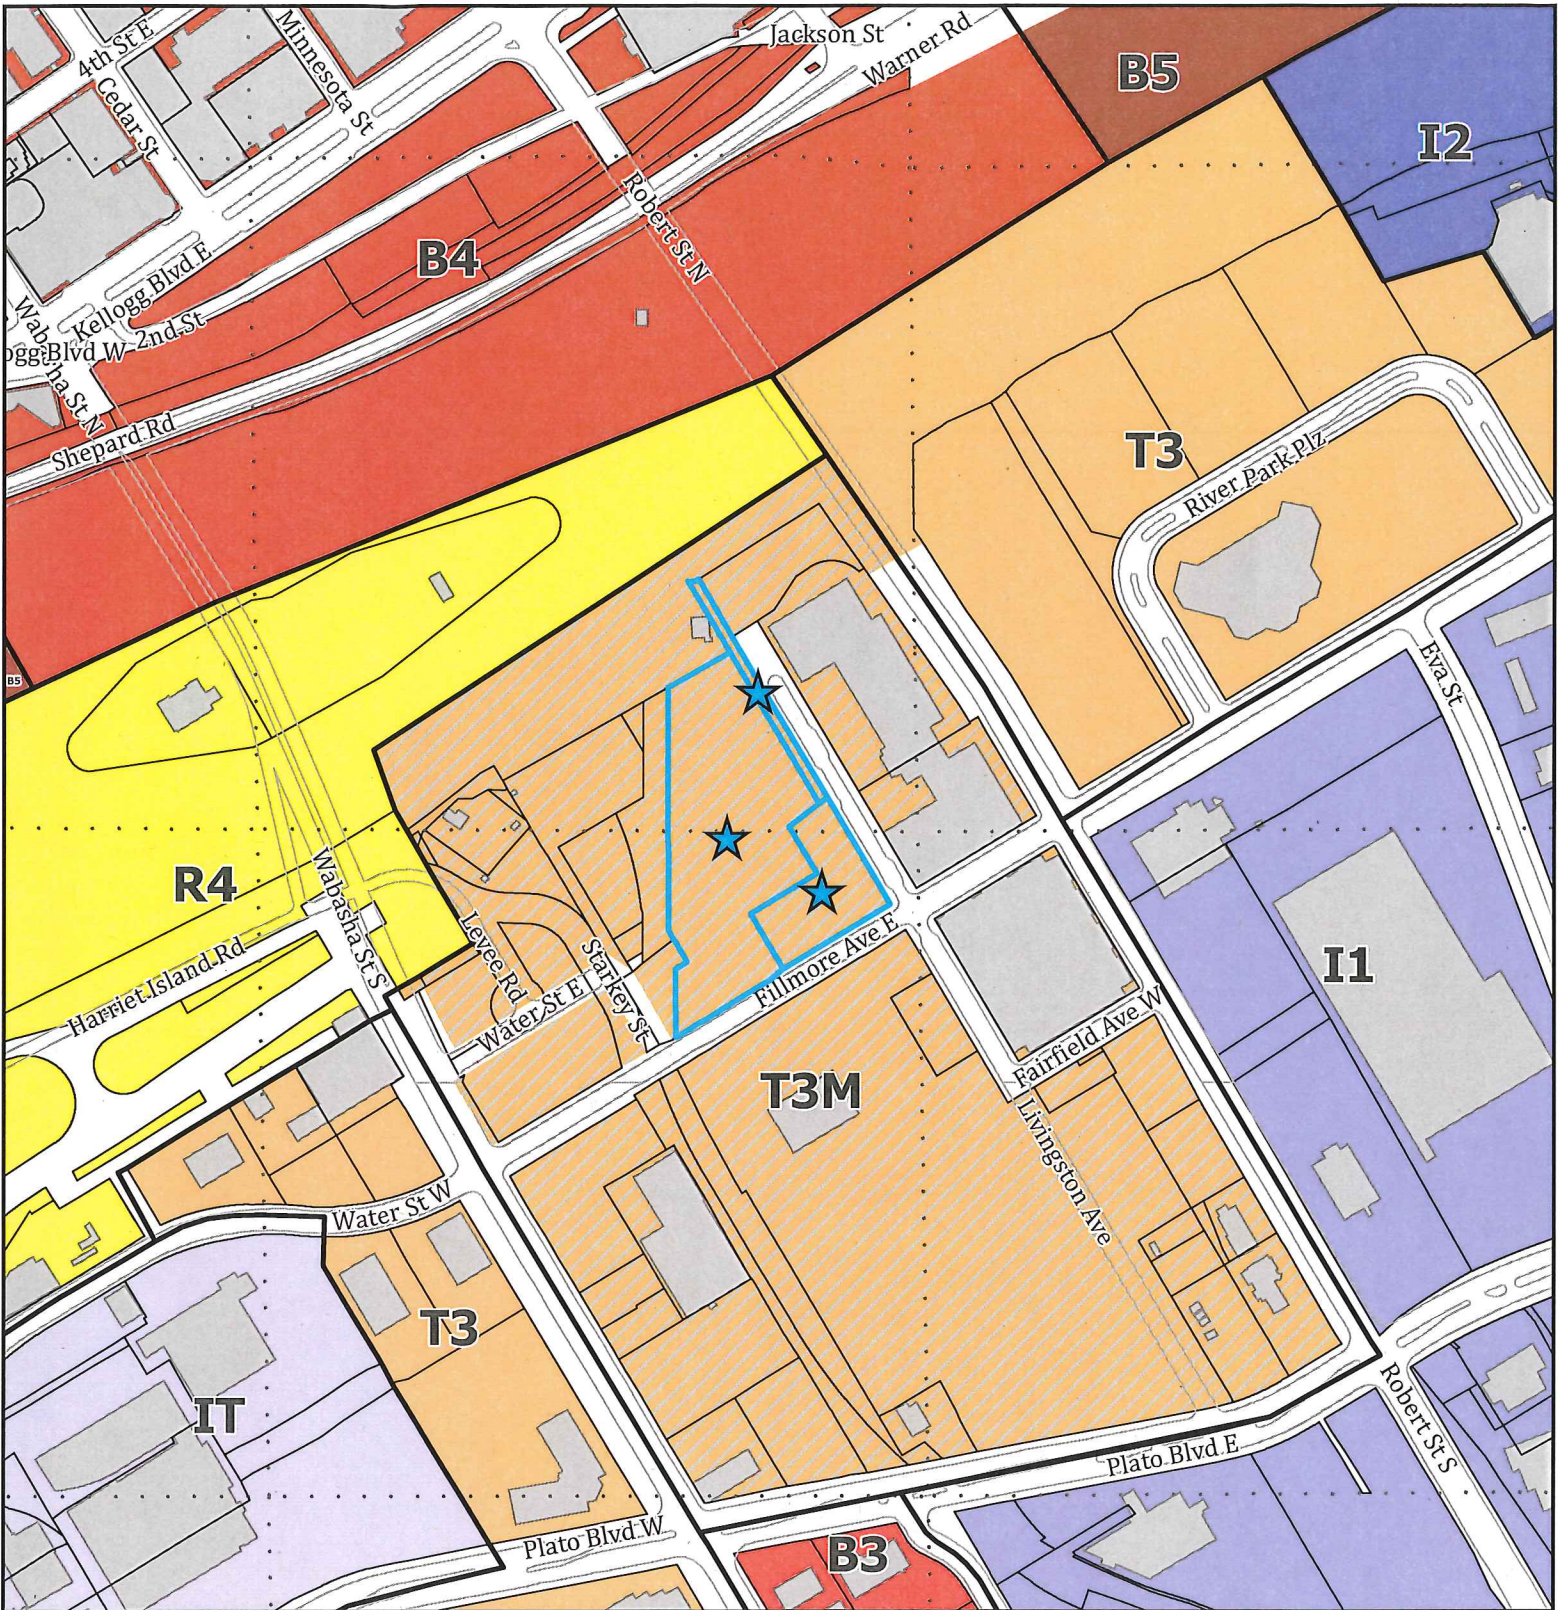
PLANNING DISTRICT: 3

ZONING PANEL: 16

Land Use

- Office
- Retail and Other Commercial
- Mixed Use Residential
- Mixed Use Commercial and Other
- Industrial and Utility
- Institutional
- Park, Recreational or Preserve
- Railway
- Undeveloped
- Water
- Subject Parcels
- Section Lines



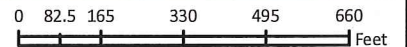

FILE NAME: West Side Flats Phase 3A and 3B

APPLICATION TYPE: CUP

FILE #: 15-031255 DATE: 4/30/2015

PLANNING DISTRICT: 3

ZONING PANEL: 16

Zoning

- R4 One-Family
- T3 Traditional Neighborhood
- T3M T3 with Master Plan
- B3 General Business
- B4 Central Business
- B5 Central Business Service
- IT Transitional Industrial
- I1 Light Industrial
- I2 General Industrial
- Subject Parcels
- Section Lines

