









HPC FORMAL REVIEW project: IRVINE RESIDENCE date: 11 13 2014

scale: AS SHOWN

COVER SHEET

drawn by: WJ

sheet title

4	11 13 2014	HPC FORMAL REVIEW REVISION
3	10 02 2014	HPC FORMAL REVIEW
2	09 22 2014	SITE PLAN REVIEW REVISION
1	08 19 2014	SITE PLAN REVIEW



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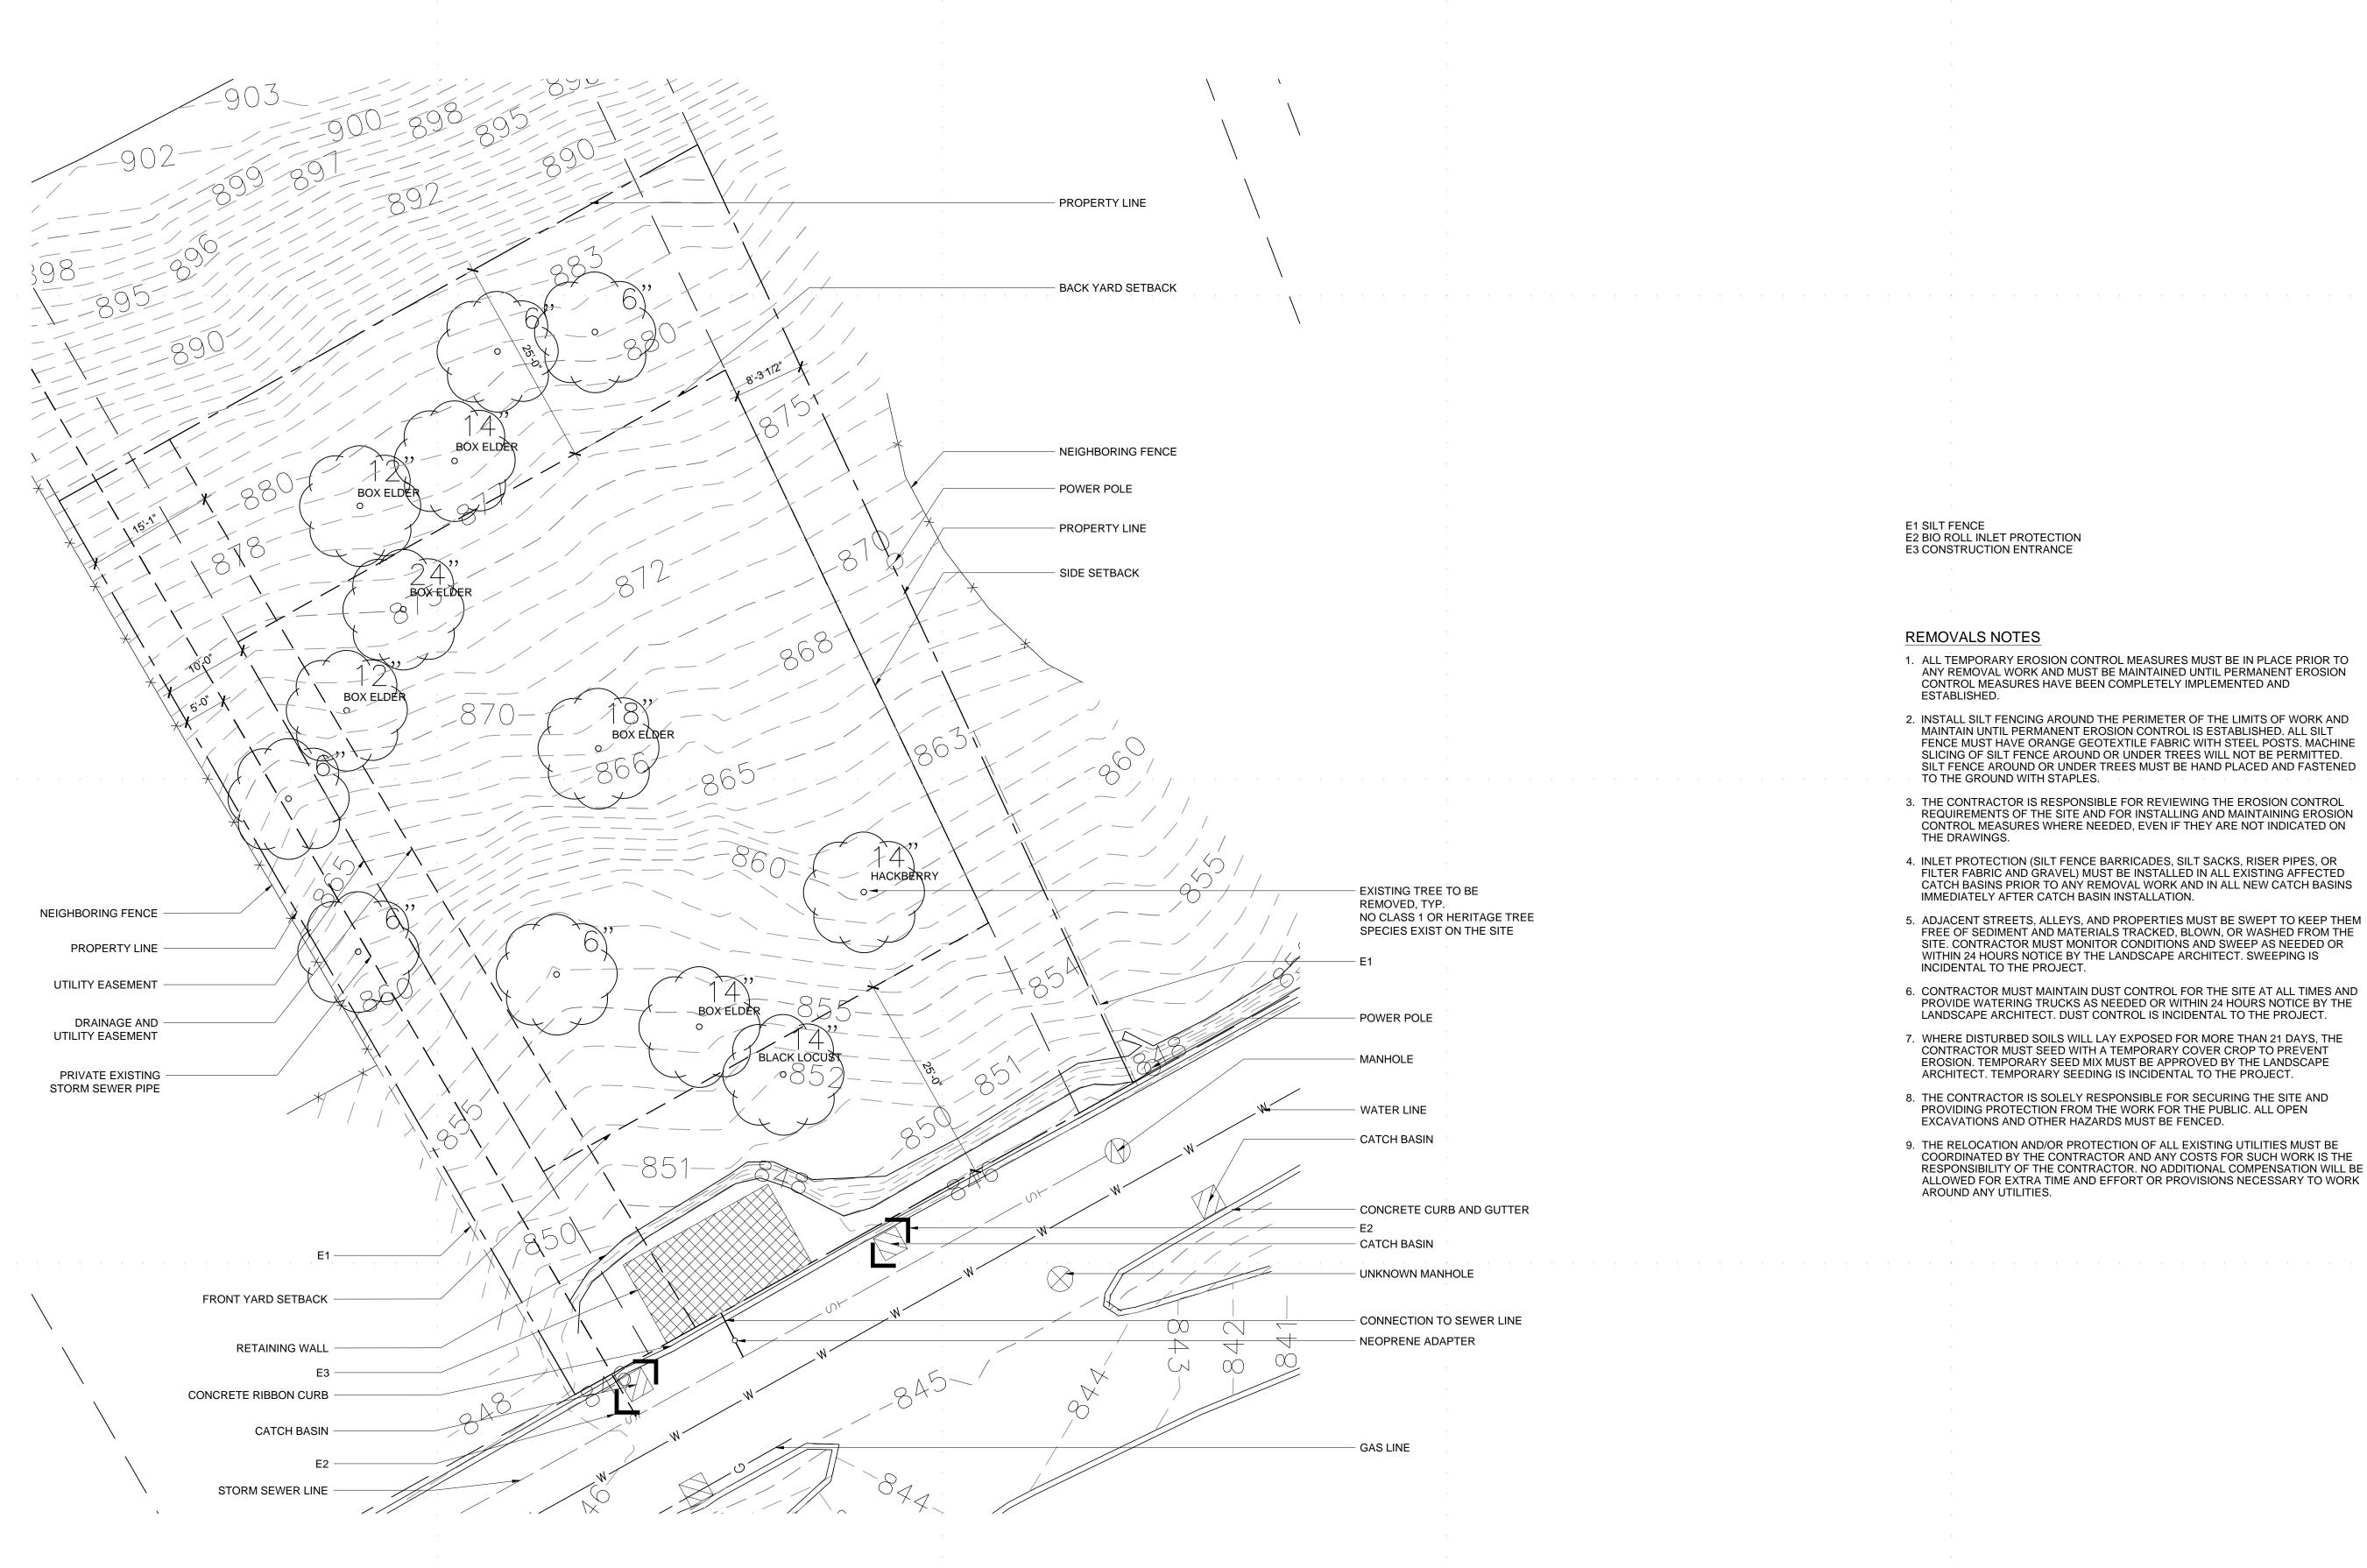
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LANDSCAPE ARCHITECT

102 52 NΝ Π C, ST Ш >VINE 2 321

EXISTING CONDITIONS / REMOVALS Scale:1" = 10'-0"





E1 SILT FENCE E2 BIO ROLL INLET PROTECTION E3 CONSTRUCTION ENTRANCE

REMOVALS NOTES

THE DRAWINGS.

INCIDENTAL TO THE PROJECT.

AROUND ANY UTILITIES.

- 1. ALL TEMPORARY EROSION CONTROL MEASURES MUST BE IN PLACE PRIOR TO ANY REMOVAL WORK AND MUST BE MAINTAINED UNTIL PERMANENT EROSION CONTROL MEASURES HAVE BEEN COMPLETELY IMPLEMENTED AND ESTABLISHED.
- 2. INSTALL SILT FENCING AROUND THE PERIMETER OF THE LIMITS OF WORK AND MAINTAIN UNTIL PERMANENT EROSION CONTROL IS ESTABLISHED. ALL SILT FENCE MUST HAVE ORANGE GEOTEXTILE FABRIC WITH STEEL POSTS. MACHINE SLICING OF SILT FENCE AROUND OR UNDER TREES WILL NOT BE PERMITTED. SILT FENCE AROUND OR UNDER TREES MUST BE HAND PLACED AND FASTENED TO THE GROUND WITH STAPLES.
- 3. THE CONTRACTOR IS RESPONSIBLE FOR REVIEWING THE EROSION CONTROL

SITE. CONTRACTOR MUST MONITOR CONDITIONS AND SWEEP AS NEEDED OR

PROVIDE WATERING TRUCKS AS NEEDED OR WITHIN 24 HOURS NOTICE BY THE

EROSION. TEMPORARY SEED MIX MUST BE APPROVED BY THE LANDSCAPE ARCHITECT. TEMPORARY SEEDING IS INCIDENTAL TO THE PROJECT.

COORDINATED BY THE CONTRACTOR AND ANY COSTS FOR SUCH WORK IS THE

ALLOWED FOR EXTRA TIME AND EFFORT OR PROVISIONS NECESSARY TO WORK

WITHIN 24 HOURS NOTICE BY THE LANDSCAPE ARCHITECT. SWEEPING IS

IMMEDIATELY AFTER CATCH BASIN INSTALLATION.

- REQUIREMENTS OF THE SITE AND FOR INSTALLING AND MAINTAINING EROSION CONTROL MEASURES WHERE NEEDED, EVEN IF THEY ARE NOT INDICATED ON

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LANDSCAPE ARCHITECT

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Smansignature: date: XX-XX-XXXX license no: xx

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HPC FORMAL REVIEW

EXISTING CONDITIONS / REMOVALS

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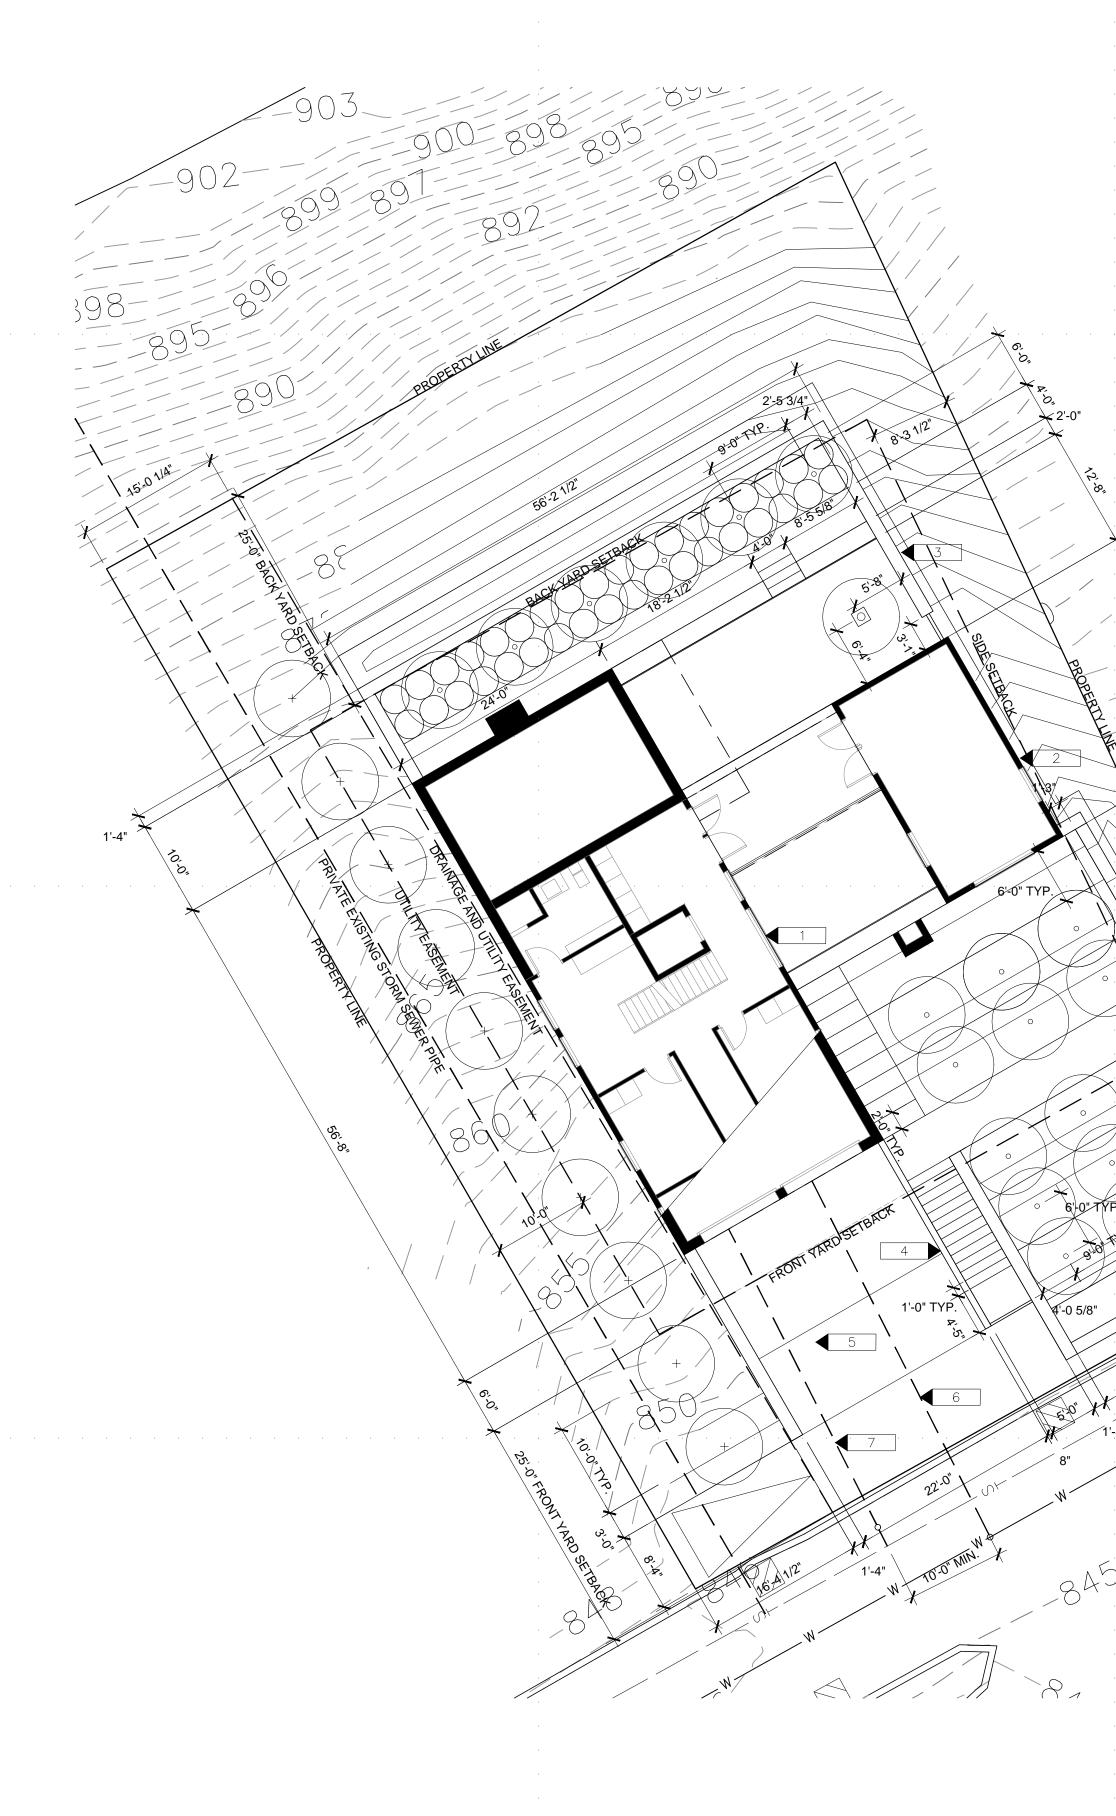
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sheet title





- PROPOSED PRIMARY STRUCTURE; WOOD FRAME
- PROPOSED CARRIAGE HOUSE; WOOD FRAME
- 3 **RETAINING WALL, TYP., MASONRY**
- 4 ENTRY FENCE AND GATE
- DRIVEWAY
- 6 CONNECTION TO WATER LINE, 2" PVC
- CONNECTION TO SEWER LINE, 6" PVC

SITE AREA: 9992 SQFT BUILDING COVERAGE: 18.4% IMPERVIOUS COVERAGE: 41.9%

UTILITY NOTES

INSPECTION CONTACT:

The developer shall contact the Right of Way inspector Long Yang, (651) 485-4398 (one week prior to beginning work) to discuss traffic control, pedestrian safety and coordination of all work in the public right of way. Note: If a one week notice is not provided to the City, any resulting delays shall be the sole responsibility of the Contractor.

SAFE WORK SITE REQUIREMENTS:

The Contractor shall provide a continuous, accessible and safe pedestrian walkway that meets ADA and MN MUTCD standards if working in a sidewalk area, and traffic control per MN MUTCD requirements for work in the public right of way.

NO PRIVATE FACILITIES IN THE RIGHT OF WAY:

The developer is strictly prohibited from installing private electrical wiring, conduit, receptacles and/or lighting in the City's Right of Way. This includes stubbing conduit or cable into the public right of way to accommodate utility feeds to the site. Coordinate with each utility prior to construction to determine feed points into the property. Utilities are responsible for securing excavation permits to run their service into a site, and (where required) submitting plans for review by the Public Works Utility Review Committee.

CITY OF ST. PAUL PERMIT REQUIREMENTS: ORDERING OBSTRUCTION AND EXCAVATION PERMITS:

Contact Public Works Right of Way Service Desk at (651) 266-6151. It is strongly recommended that contractors call for cost estimates prior to bidding to obtain accurate cost estimates.

OBSTRUCTION PERMITS:

The contractor must obtain an Obstruction Permit if construction (including silt fences) will block City streets, sidewalks or alleys, or if driving over curbs.

EXCAVATION PERMITS:

All digging in the public right of way requires an Excavation Permit. If the proposed building is close to the right of way, and excavating into the right of way is needed to facilitate construction, contact the utility inspector.

FAILURE TO SECURE PERMITS:

Failure to secure Obstruction Permits or Excavation Permits will result in a double-permit fee and other fees required under City of St. Paul Legislative Codes.

REQUIREMENTS TO WORK IN THE PUBLIC RIGHT OF WAY:

All utilities and contractors working in the public right of way must be registered.





SITE LAYOUT PLAN

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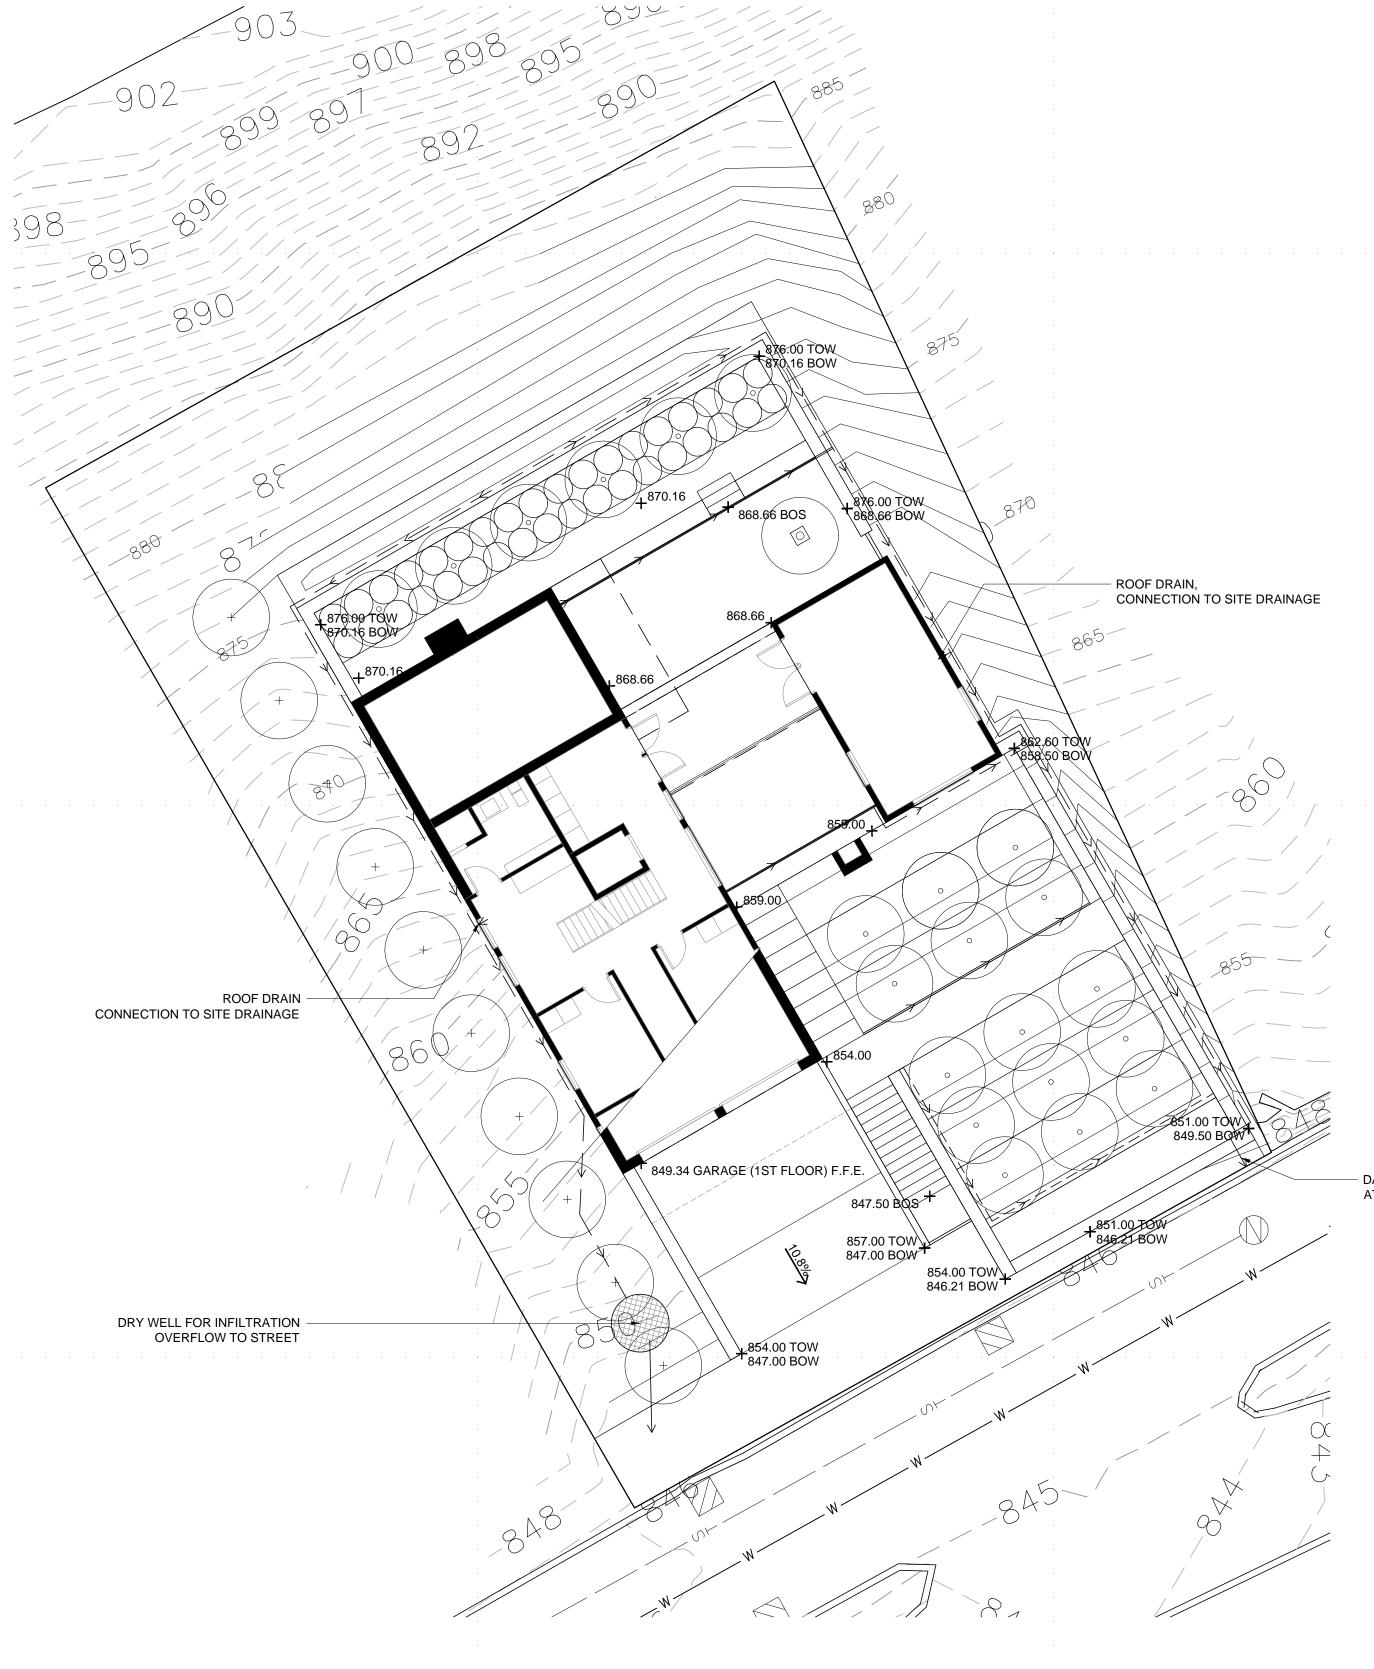
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LANDSCAPE ARCHITECT



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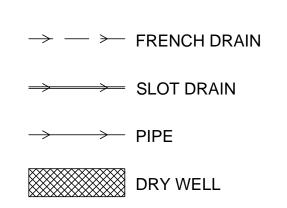





GRADING NOTES

- 1. PROVIDE AND MAINTAIN POSITIVE DRAINAGE AWAY FROM ALL STRUCTURES AT ALL TIMES.
- ALL DESIGN CONTOURS AND PROPOSED ELEVATIONS INDICATED ARE TO FINISH GRADE UNLESS OTHERWISE NOTED.
- 3. THE CONTRACTOR SHALL ACCOUNT FOR ALL IMPORTED SURFACE AND PLANTING MATERIALS IN DETERMINING EARTHWORK REQUIREMENTS.
- 4. GRADING OPERATIONS MUST MINIMIZE THE POTENTIAL FOR EROSION.
- 5. NO GRADING, STOCKPILING OF MATERIALS, OR STAGING IS PERMITTED OUTSIDE THE LIMITS OF WORK.
- 6. PRIOR TO ROUGH GRADING THE SITE, THE CONTRACTOR MUST REMOVE ALL TOPSOIL IN AREAS TO BE DISTURBED AND STOCKPILE ON SITE FOR FUTURE USE. EXCESS TOPSOIL MUST BE REMOVED FROM THE SITE AFTER FINISH GRADING AT THE CONTRACTOR'S EXPENSE.
- 7. THE EARTHWORK FOR THE SITE IS ANTICIPATED TO PRODUCE AN EXCESS OF MATERIAL. THE CONTRACTOR MUST REMOVE ALL EXCESS MATERIAL FROM THE SITE AND DISPOSE OF IT AT THE CONTRACTOR'S EXPENSE.
- 8. NO TOPSOIL SHALL BE REMOVED FROM RESTORATION AREAS WITHOUT APPROVAL FROM THE LANDSCAPE ARCHITECT AND RESTORATION CONTRACTOR.
- 9. TOPSOIL COMPACTED BY CONSTRUCTION TRAFFIC IN RESTORATION AREAS SHALL BE LOOSENED UNDER THE DIRECTION OF THE LANDSCAPE ARCHITECT AND RESTORATION CONTRACTOR.

- DAYLIGHT FRENCH DRAIN AT RETAINING WALL



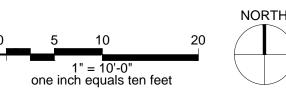



GRADING AND DRAINAGE PLAN

sheet title

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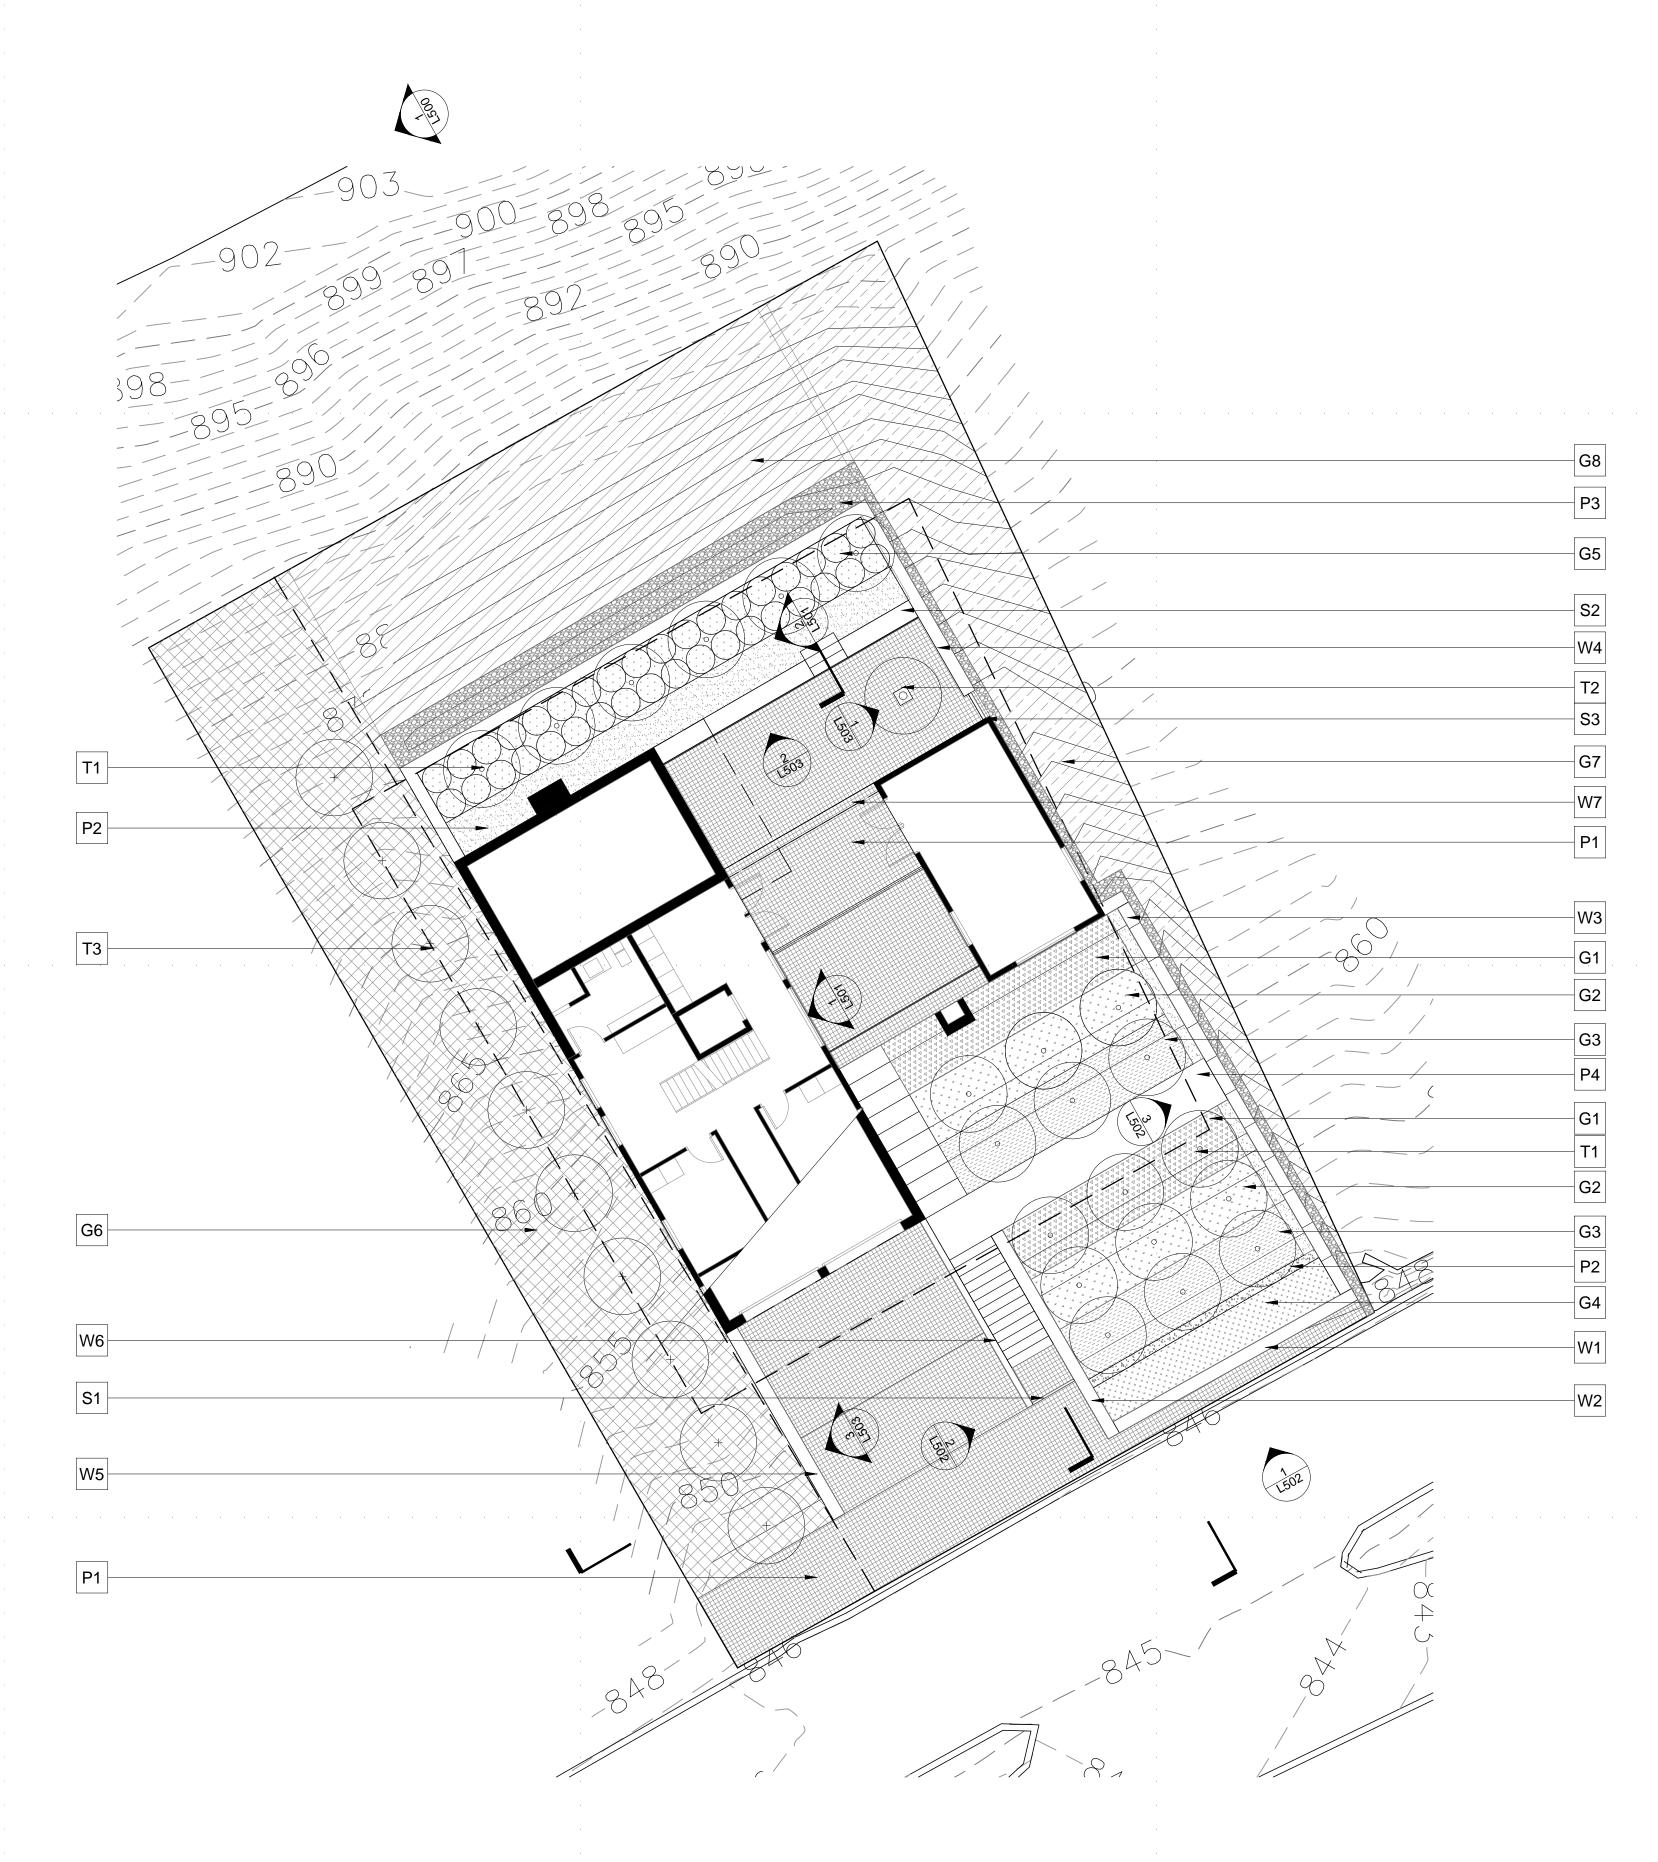
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LANDSCAPE PLAN Scale:1" = 10'-0"



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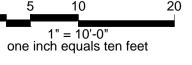
G8	<i>Vaccinium angustifolium</i> Lowbush Blueberry	#1 container	275	Plant 24" O.C. in grid pattern.
	· · ·			
WAL				
KEY	DESCRIPTION		COMMEN	NTS
W1	Concrete Retaining Wall		Front yard detail.	d, parallel to street. Refer to L600/1 for
W2	Concrete Retaining Wall		Front yard for detail.	d, east of entry stairs. Refer to L600/2
W3	Concrete Retaining Wall		Front yard for detail.	d, east of entry garden. Refer to L600/
W4	Concrete Retaining Wall		Back yard	d. Refer to L600/4 for detail.
W5	Concrete Retaining Wall		West of d	Iriveway. Refer to L600/5 for detail.
W6	Perforated Metal Wall		West of e	entry stairs. Refer to L600/2 for detail.

W6	Perforated Metal
W7	Metal Wall
SITE	ELEMENTS

KEY	DESCRIPTION	COMMENTS
S1	Perforated Metal Gate	Front entry. Refer to L502/1 for elevation.
52	Concrete Bench	Back yard. Refer to L600/7 for detail.
33	Perforated Metal Gate	Back yard. Refer to L503/1 for elevation.

SURFACING

KEY	DESCRIPTION
P1	Concrete cobble 4"x4"
P2	Aggregate
P3	Beach pebbles
P4	Concrete paving





T1 Betula nigra River Birch

KEY SPECIES

T2 Flowering Ornamental Tree Specimen 1

PLANTINGS - TREES

T3 Pinus strobus White Pine

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LANDSCAPE PLAN

HPC FORMAL REVIEW

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MN 55102 SIDENCE PAUL, 2 VIE ST. Ш R ш $\boldsymbol{\alpha}$ AV 4 Ш Z ORM 321 IRVINE C 2 НР

Landscape Architect to approve trees prior to delivery to site. Trees must be full form and 10' 10 maturing. Landscape Architect to approve trees prior to delivery to site.

QTY

COMMENTS

delivery to site.

Single stem. Trees must be full form and maturing. Landscape Architect to approve trees prior to

Specimen tree to be selected by Landscape Architect. Trees must be full form and maturing.

PLANTINGS - SHRUBS AND PERENNIALS

SIZE


2 1/2" BB 21

KEY	SPECIES	SIZE	QTY	COMMENTS
G1	Galium odoratum Sweet Woodruff	6 PK	310	Plant 12" O.C. in grid pattern.
32	<i>Astilbe japonica 'Deutschland</i> Deutschland Astilbe	#1 container	136	Plant 18" O.C. in grid pattern.
33	<i>Fern adiantum pedatum</i> Northern Maidenhair Fern	#1 container	310	Plant 12" O.C. in grid pattern.
G4	Liatris spicata 'Floristan White' Liatris Floristan White	#1 container	51	Plant 18" O.C. in grid pattern.
G5	<i>Hydrangea arborescens 'Annabelle'</i> Annabelle Hydrangea	#5 container	36	Plant 36" O.C. in grid pattern.
3 6	Shady Woodland Seed Mix by Prairie Moon		1874 sqft	Seeded over erosion control blanket for slope stabilization
G7	Mixed Height Praire Seed Mix by Prairie Moon		840 sqft	Seeded over erosion control blanket for slope stabilization
28	Vaccinium angustifolium	#1	275	Plant 24" O.C. in grid pattern

ION .	COMMENTS
bble pavers, limestone grey,	Front yard, entry court, back yard
· ·	Back yard, front yard planting maintenance strip
les	North and east of site retaining walls
aving	Stairs
8	

t 24" O C in grid pot

Main entry court. Refer to L600/6 for detail.

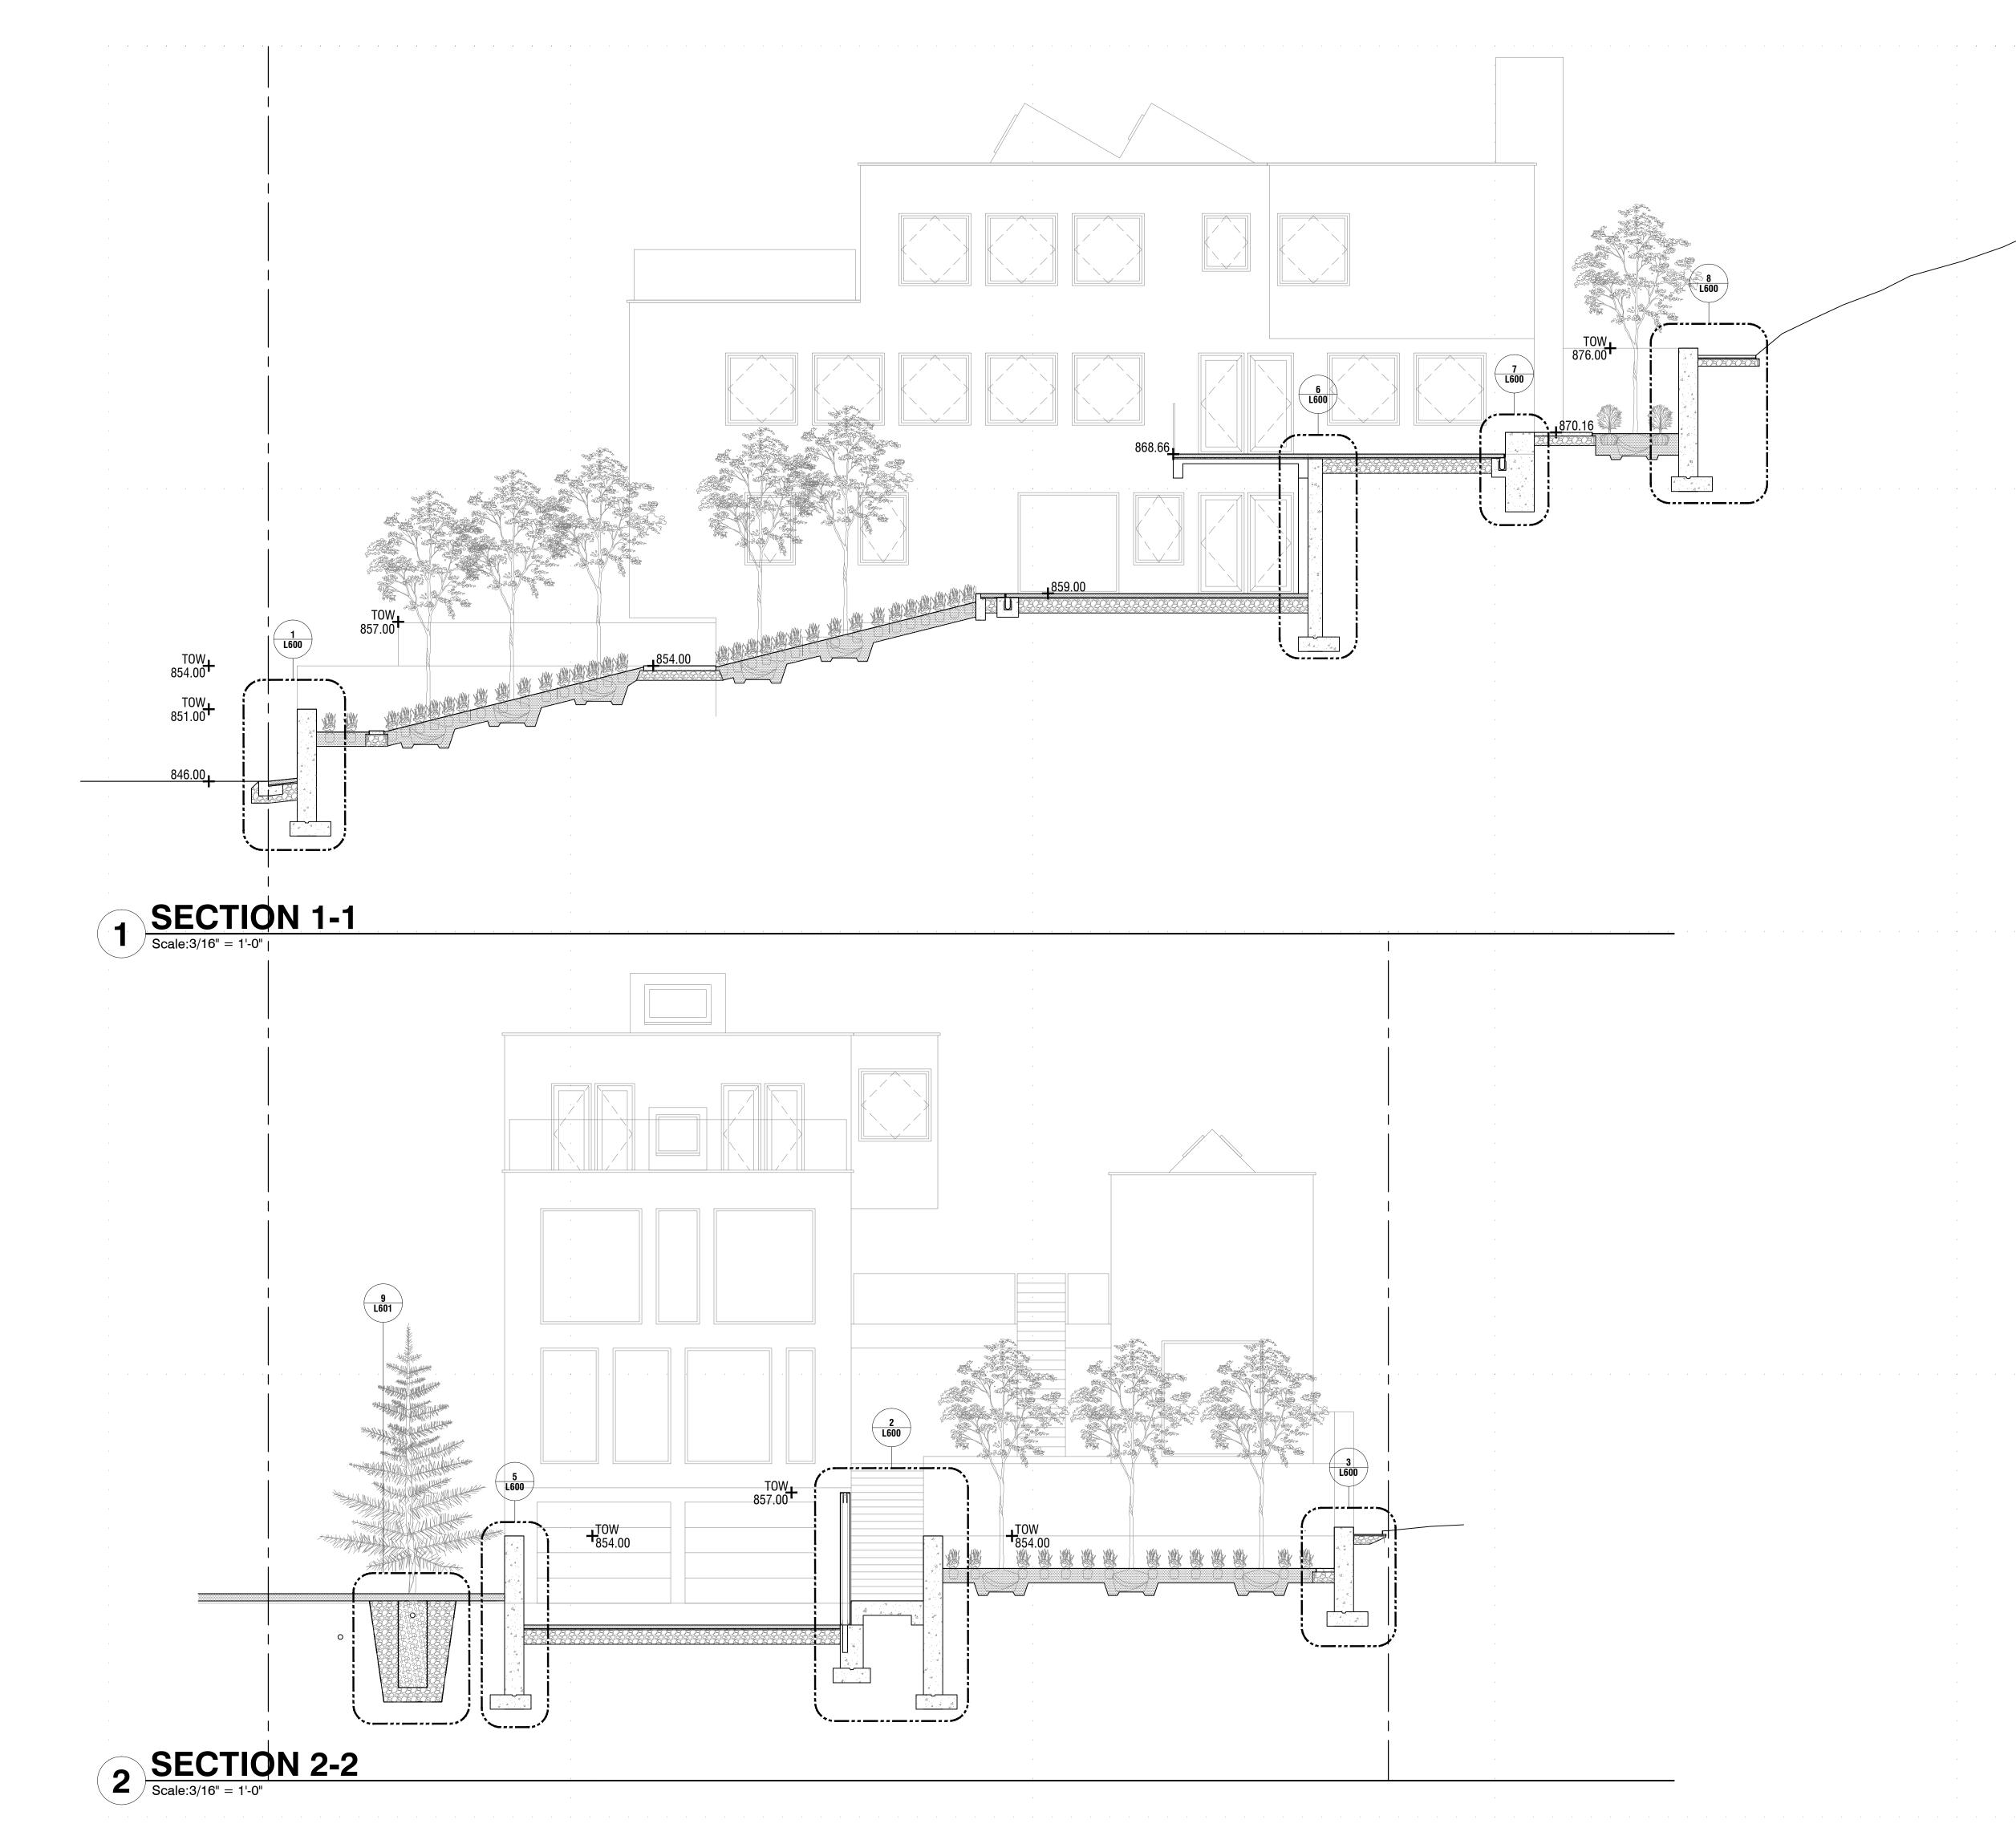



sheet title SITE SECTIONS


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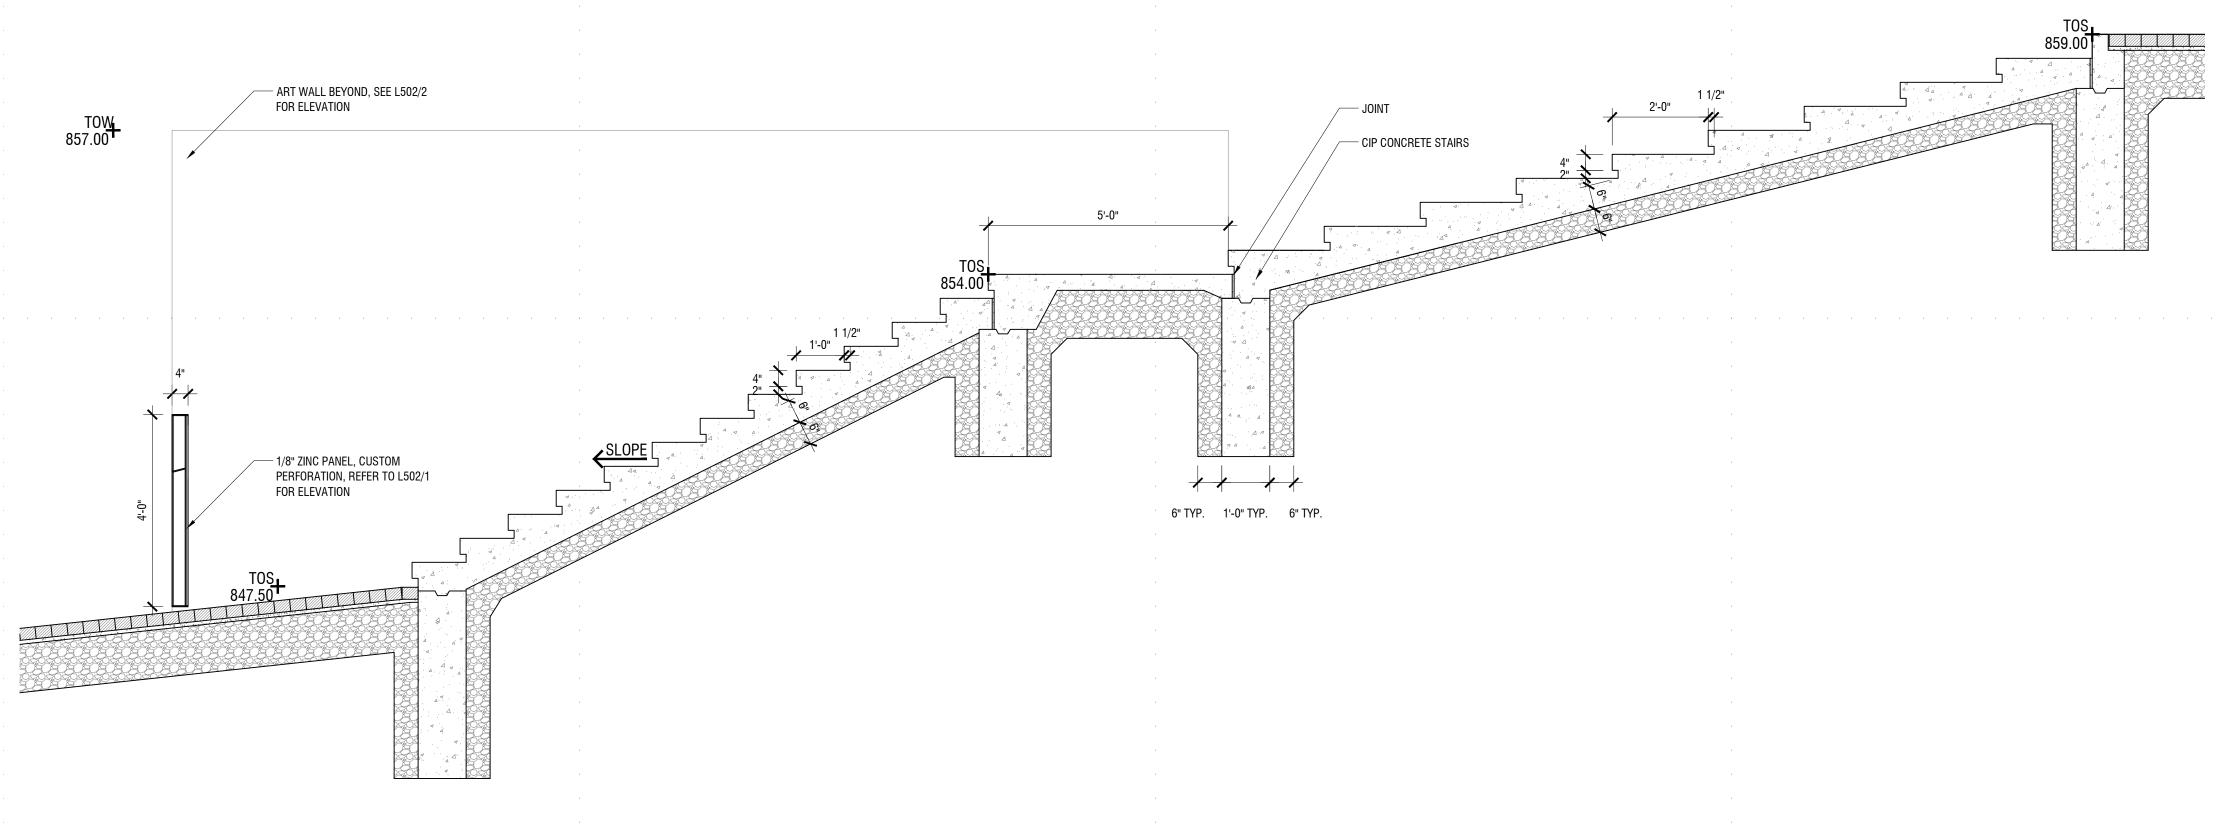


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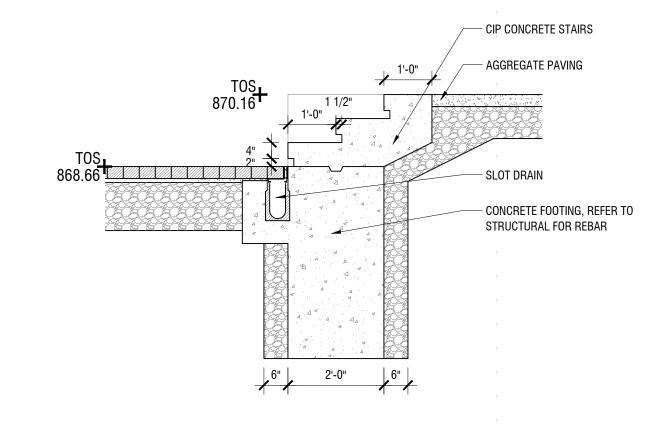
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1 FRONT ENTRY STAIRS & GATE SECTION Scale:1/2" = 1'-0"





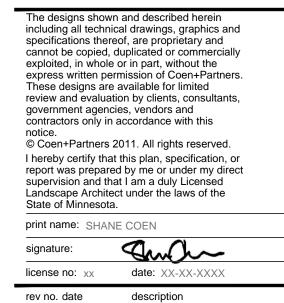

sheet title SECTIONS


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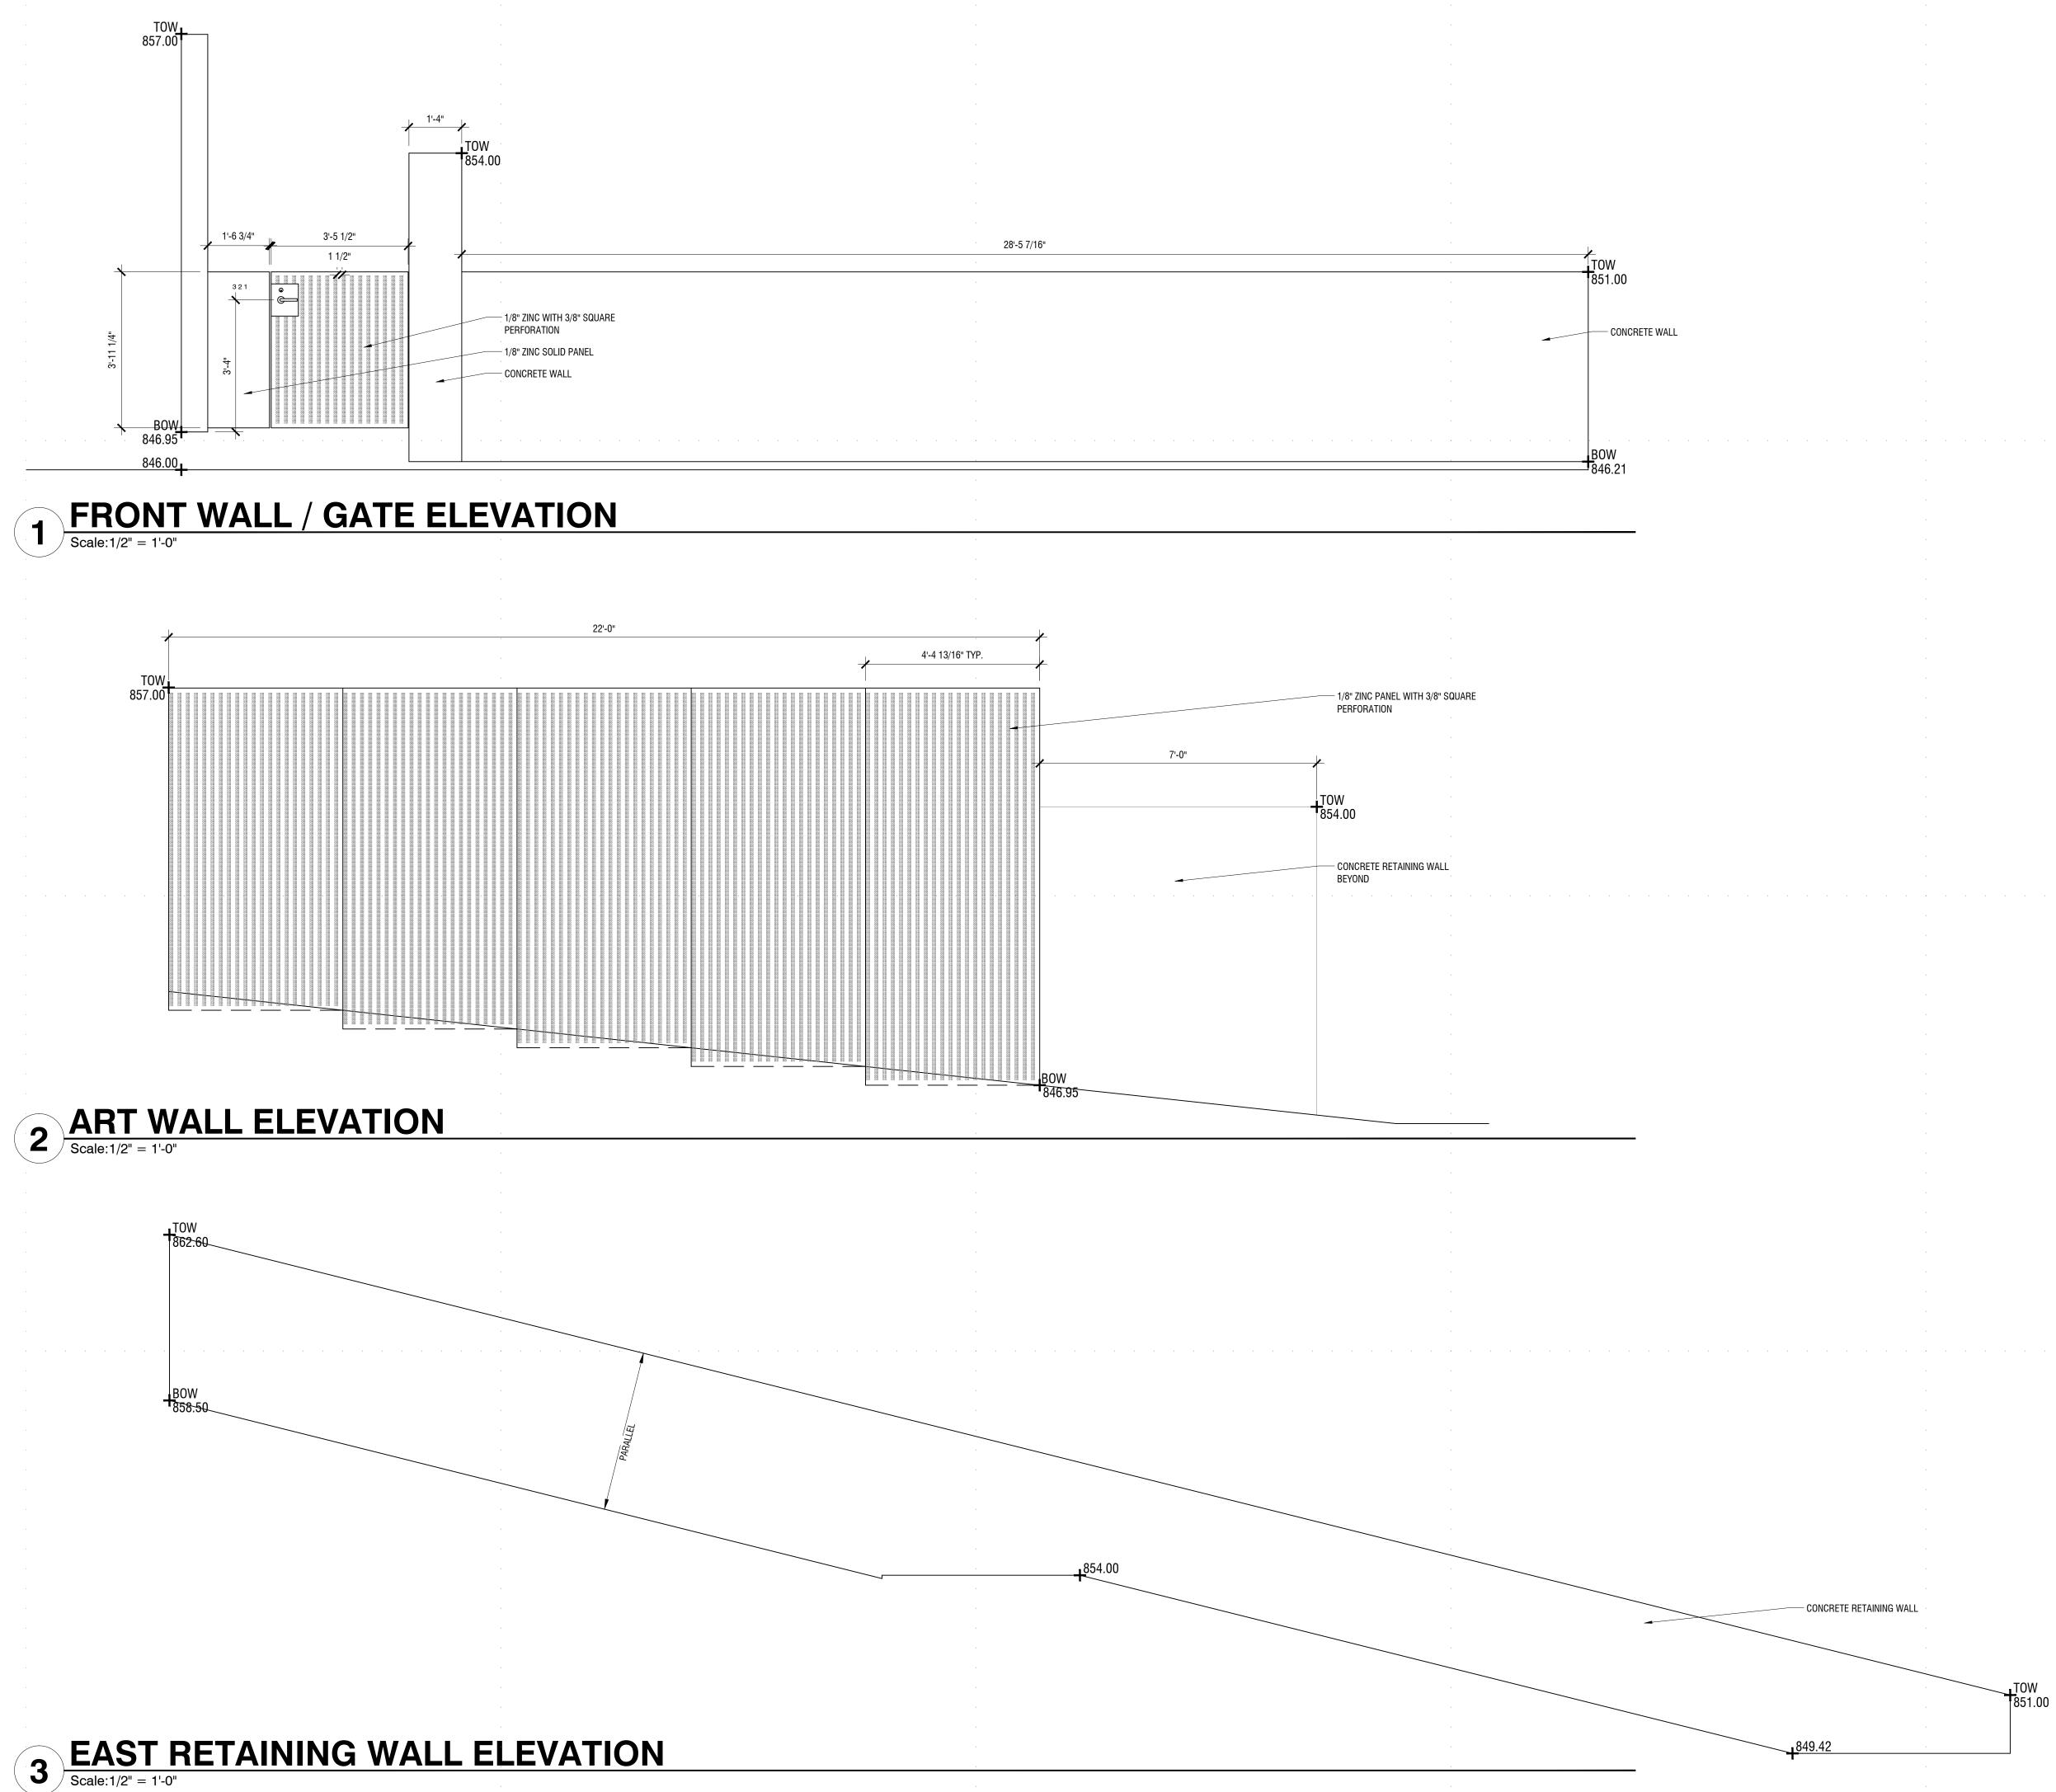
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ELEVATIONS

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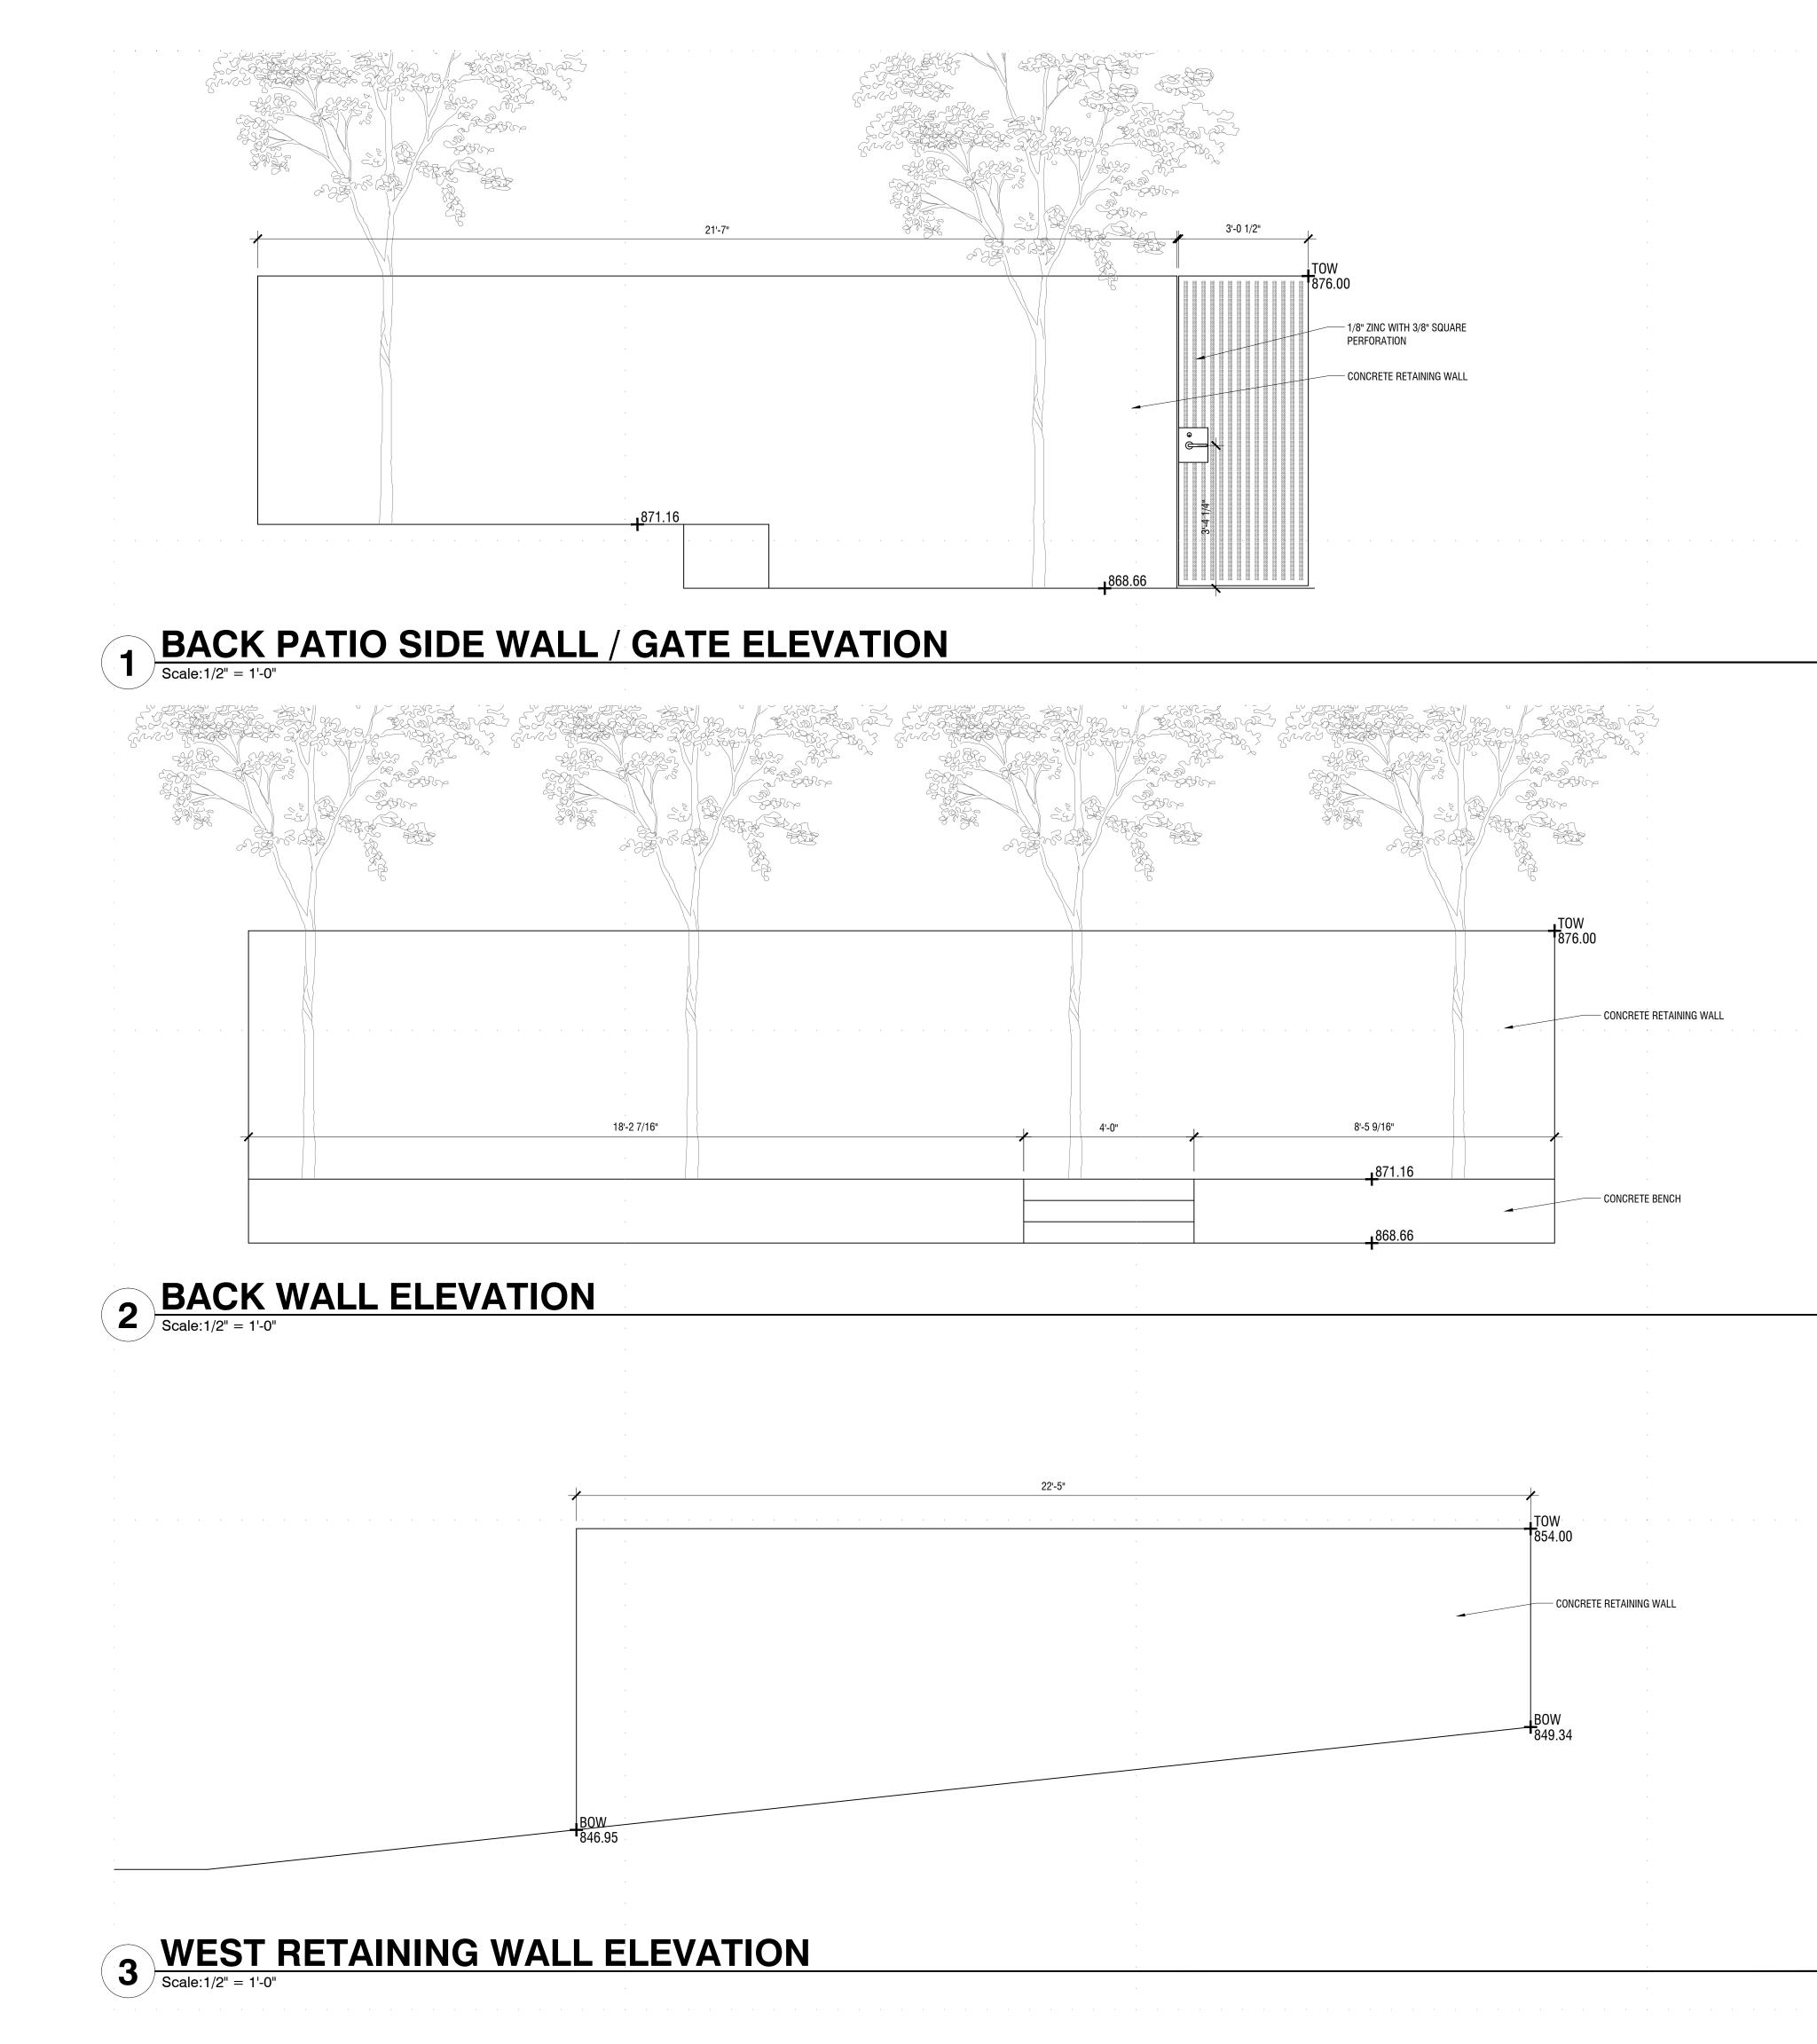
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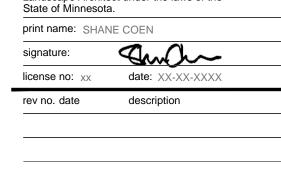




sheet title ELEVATIONS

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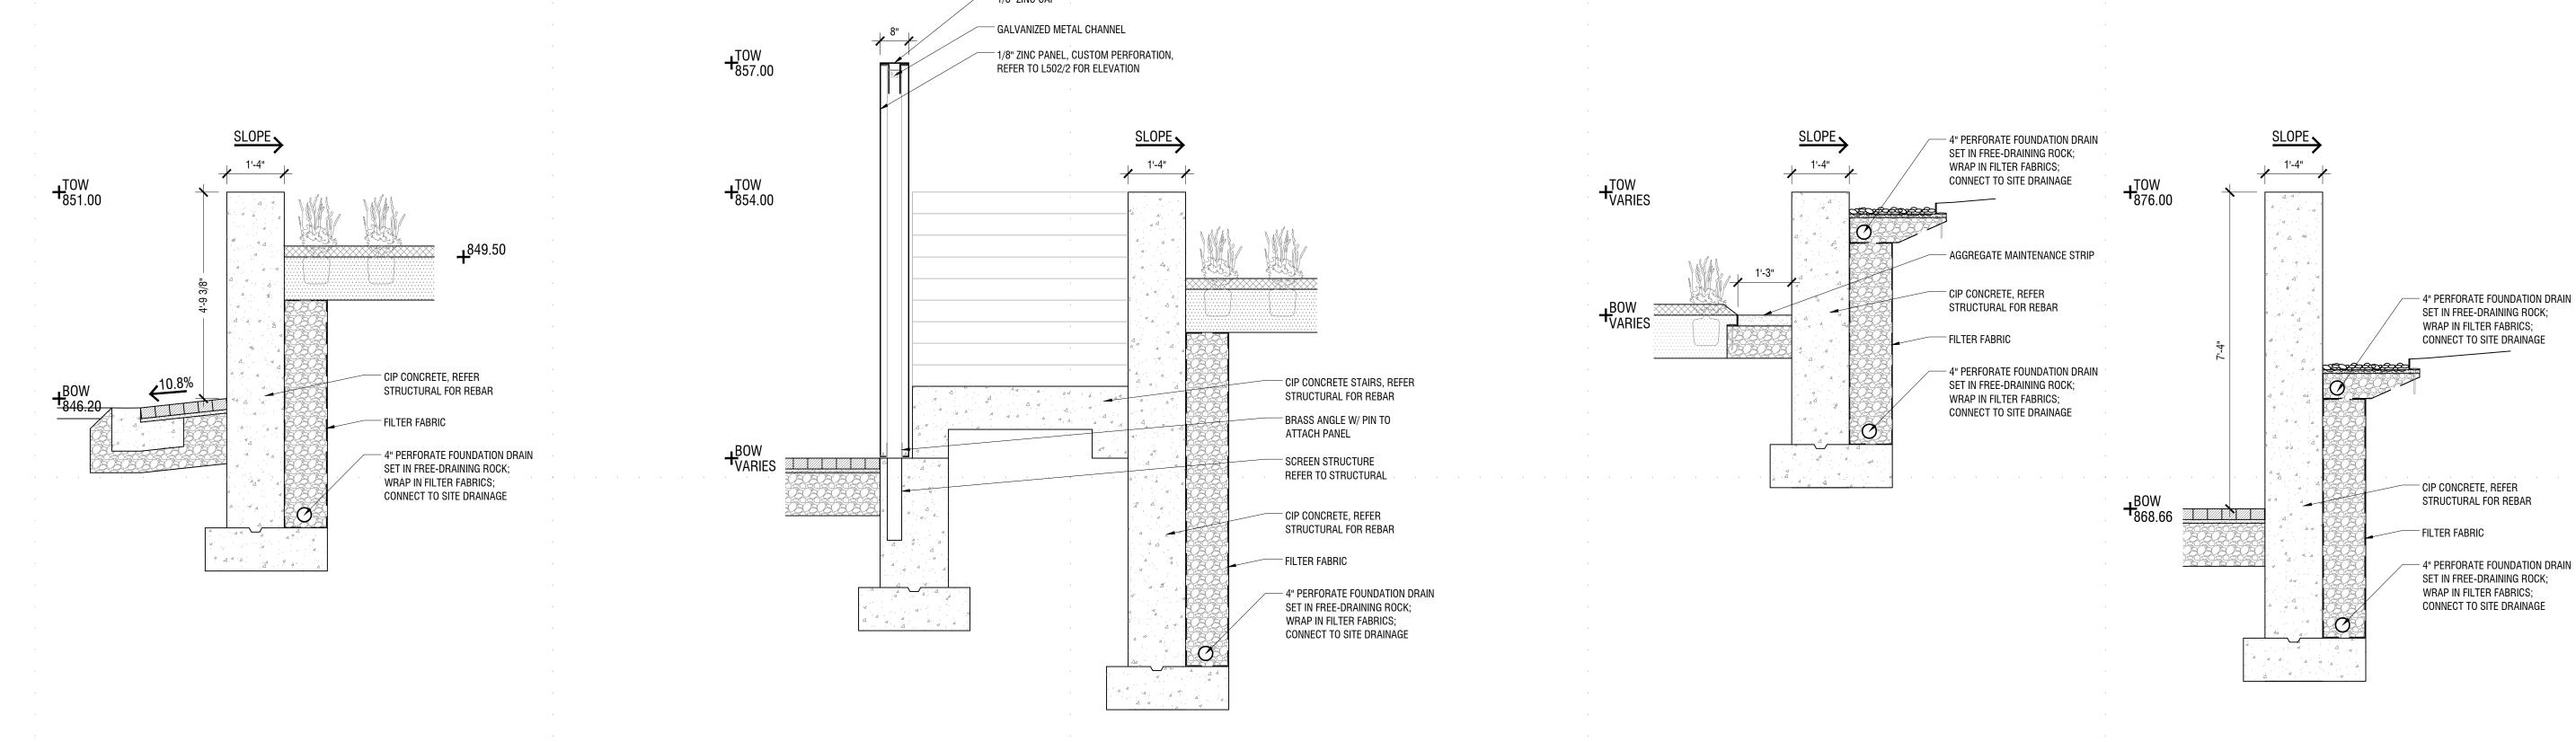
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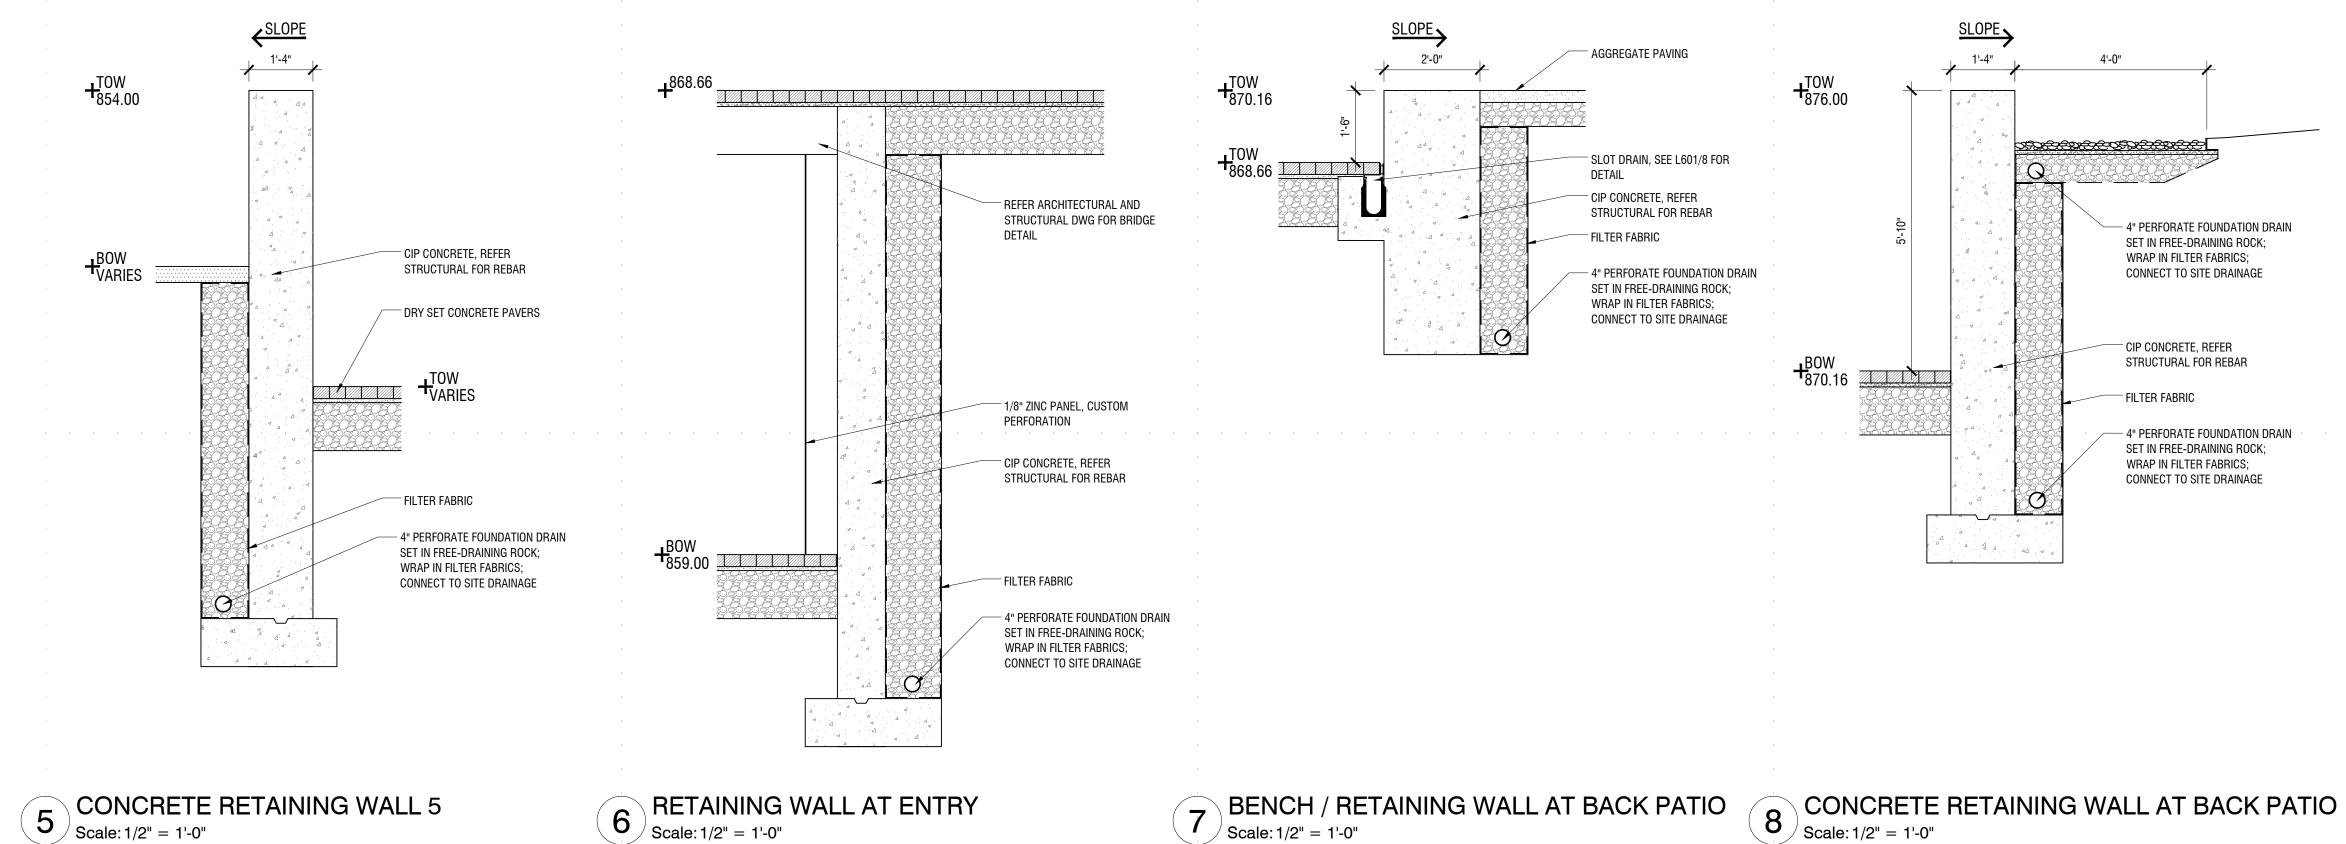
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CONCRETE RETAINING WALL 1 1 ['] Scale: 1/2" = 1'-0"

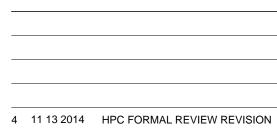





CONCRETE RETAINING WALL 3

3

[/] Scale: 1/2" = 1'-0"



WALL & GATE DETAILS

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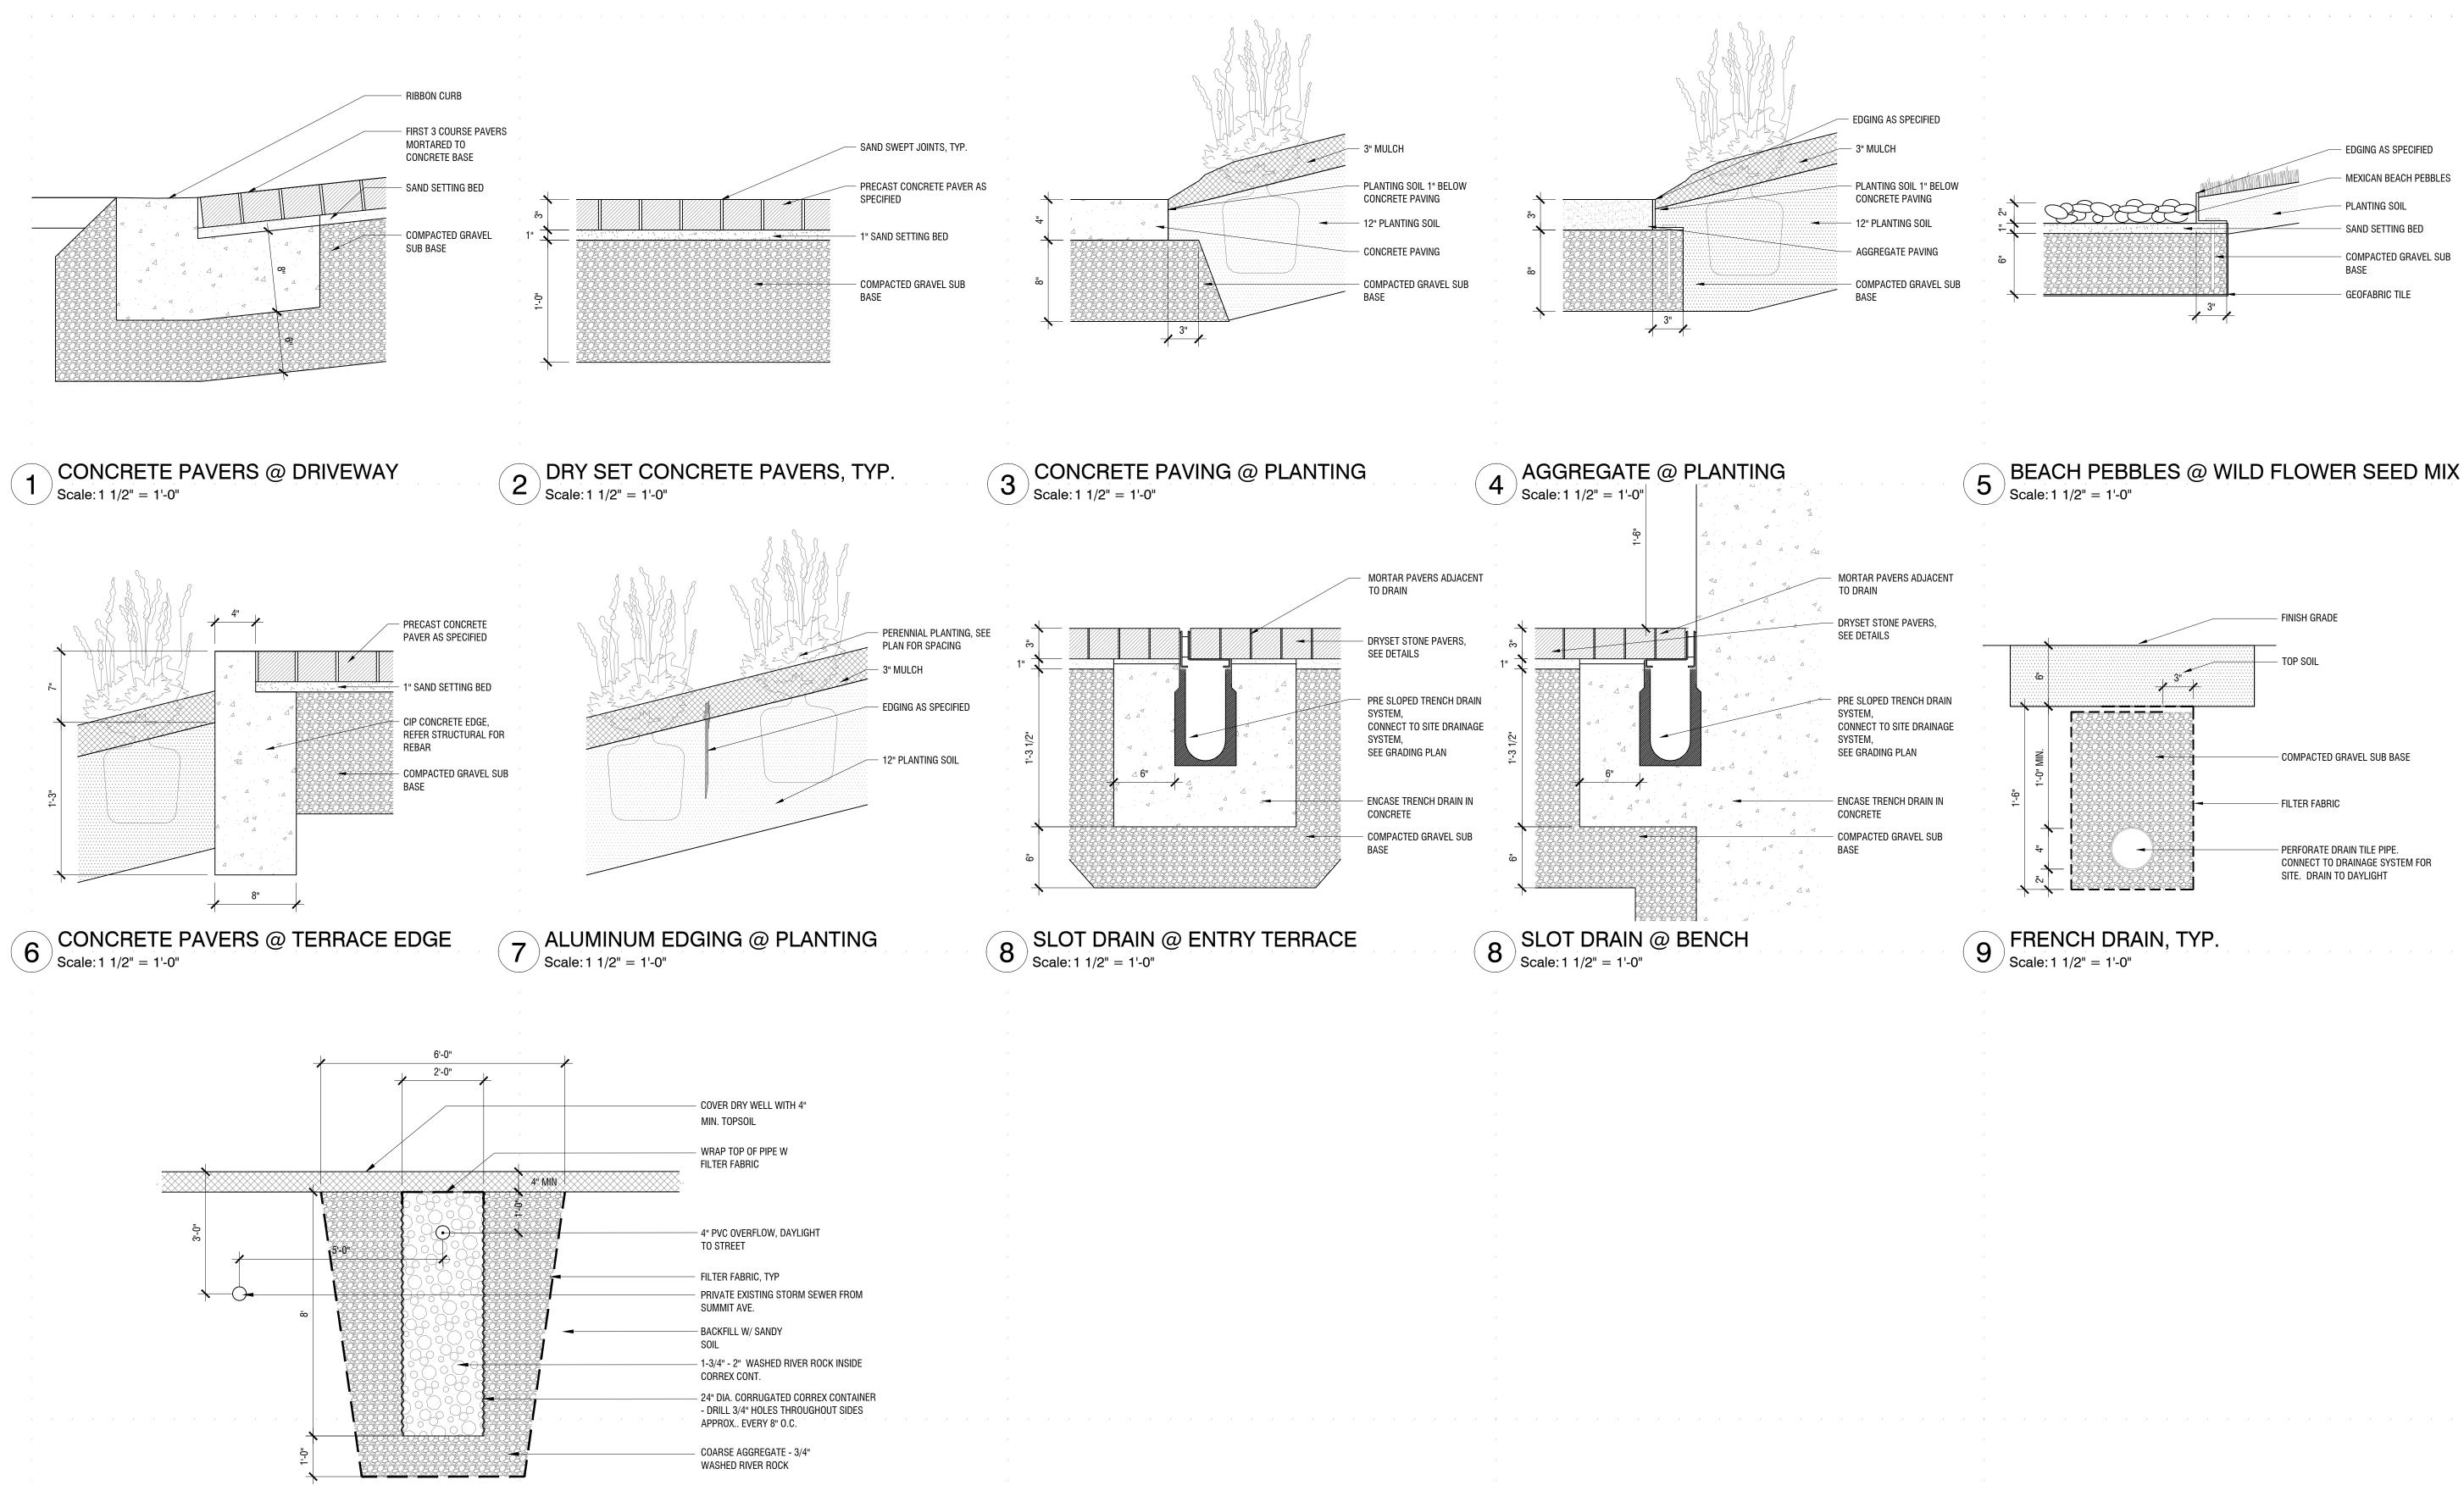
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CONCRETE RETAINING WALL 4 4 Scale: 1/2" = 1'-0"



10 AREA DRY WELL, FRENCH DRAIN OUTLET Scale: 1/2" = 1'-0"

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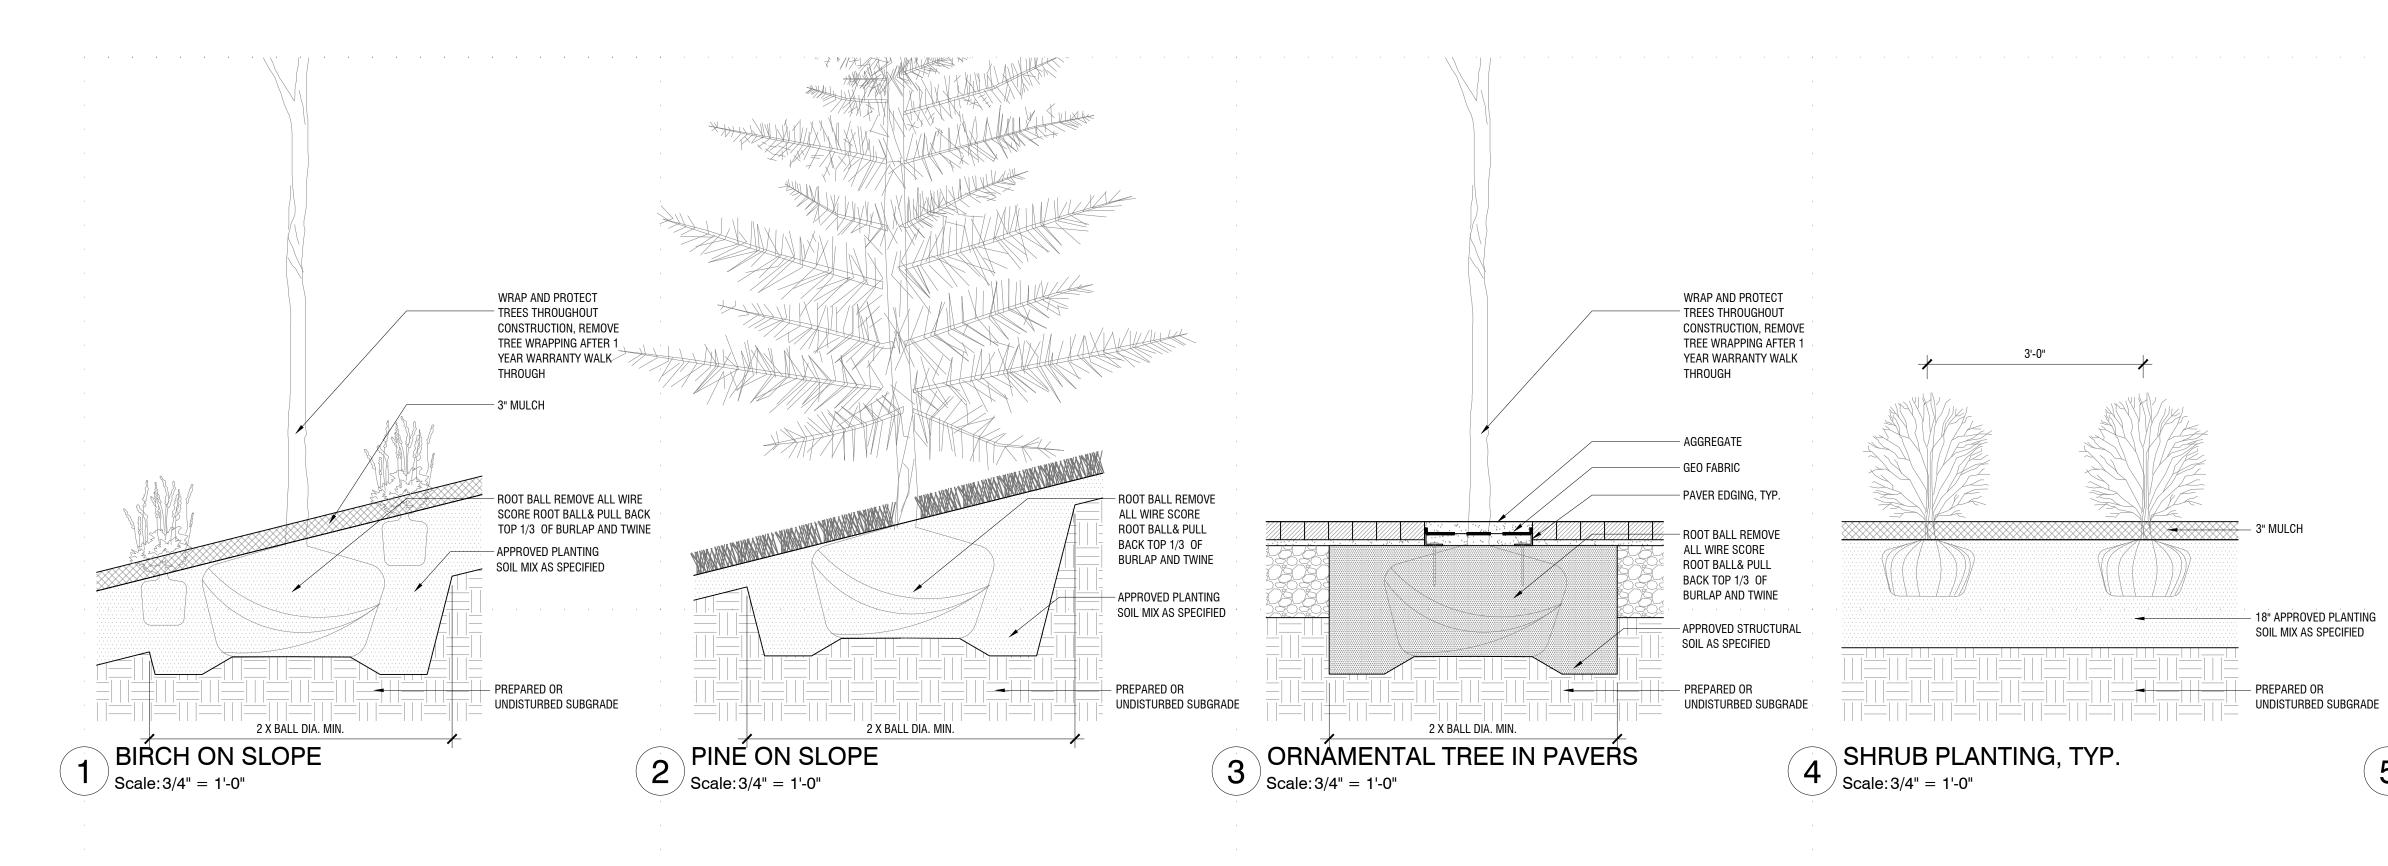
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PAVING & EDGING & DRAIN DETAILS



sheet number





PLANTING DETAILS

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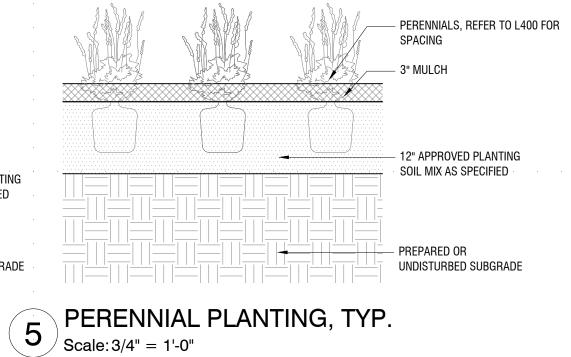
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